ADDENDUM NO. 4 - April 16, 2014

RE: Bid No. TFR-295-041614

Torrington High School

Track & Field Renovation Project

Torrington, CT 06790 GALE JN 716300

FROM: Gale Associates, Inc.

703 Hebron Avenue Glastonbury, CT 06033

TO: ALL GENERAL CONTRACTORS AND PROSPECTIVE BIDDERS OF RECORD

This Addendum forms a part of the Contract Documents and modifies the bidding documents as noted below. All bidders must acknowledge receipt of this Addendum in the space provided on the Bid Form. Failure to do so may subject the Bidder to disqualification.

The following represents additional information related to the Torrington High School Track and Field Renovation Project Specifications:

REVISIONS TO THE BID DOCUMENTS

SPECIFICATIONS:

Bid Due Date (Instructions to Bidders Section 00 2113 & Addenda 3)

 The time that bids are due is hereby revised to 11a.m. on April 22, 2014 from 3:00pm on the same day as previously noted in Addenda #3. This time modifies all advertisements for bid, Section 00 2113 – Instructions to Bidders and Addenda #3. All other bid submission requirements remain as listed in the instructions to bidders unless noted otherwise in this addendum.

Additional Black Out Date May 31, 2014. (day when contractor cannot work on site) (Conduct of the work Section 013114 1.3 D.)

1. The contractor shall revise Section 013114 1.3 D to read as follows: "The contractor shall not work on site May 7, May 31 and June 14, 2014 due to on campus events or student testing at the school"

DRAWINGS:

Bleacher Plans Sheets

1. Bidders shall disregard Bleacher sheets BL 101, BL 102, BL 103, BL 104, BL 105 and BL 106 dated 3-28-14 as included in the bid set and replace them with the attached 24" x 36" drawing sheets, BL 101, BL 102, BL 103, BL 104, BL 105 and BL 106 with a revision date of 4-15-2014. These sheets shall be added to the drawing set via this addendum. General changes include added dimensions & completed bleacher footing tables

Prebid Walk Through:

1. Attached is the list of attendees from the prebid walk through which was held at 3:00 p.m. on April 11, 2014

Attachments:

Documents:

Prebid Walk through Attendees

1 page

Drawings:

BL101- Home Bleacher/Pressbox Layout and Section Plan

BL102 - Home Bleacher/Pressbox Foundation and Details Plan

BL103 - Home Bleacher/Pressbox Layout and Section Plan (alternate)

BL104 – Home Bleacher/Pressbox Foundation & Details Plan (alternate)

BL105 – Visitor Bleacher Layout and Section Plan (alternate)

BL106 – Visitor Bleacher Foundation and Details Plan (alternate)


END OF ADDENDUM 4


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City of Torrington Bid #TFR – 295-041614 Pre-Bid Walk Thru 4-11-2014

Torrington High School Track & Field Renovations

Company	Name	E-Mail
Mather Corp. Spinturf Guerrera Construction Tabacco & Son Mountain View Inn H.I. Stone	Gerald Frisbie Allen Hubbard Bob Rossi Louie Kosak Steve Zoto Chuck Stone	mihadias@mathercorp.com ahubbard@sprinturf.com edh@guerreraconstruction.com louie@tabaccoconstruction.com stevez@mountainviewinc.com cstonejr@histoneson.com



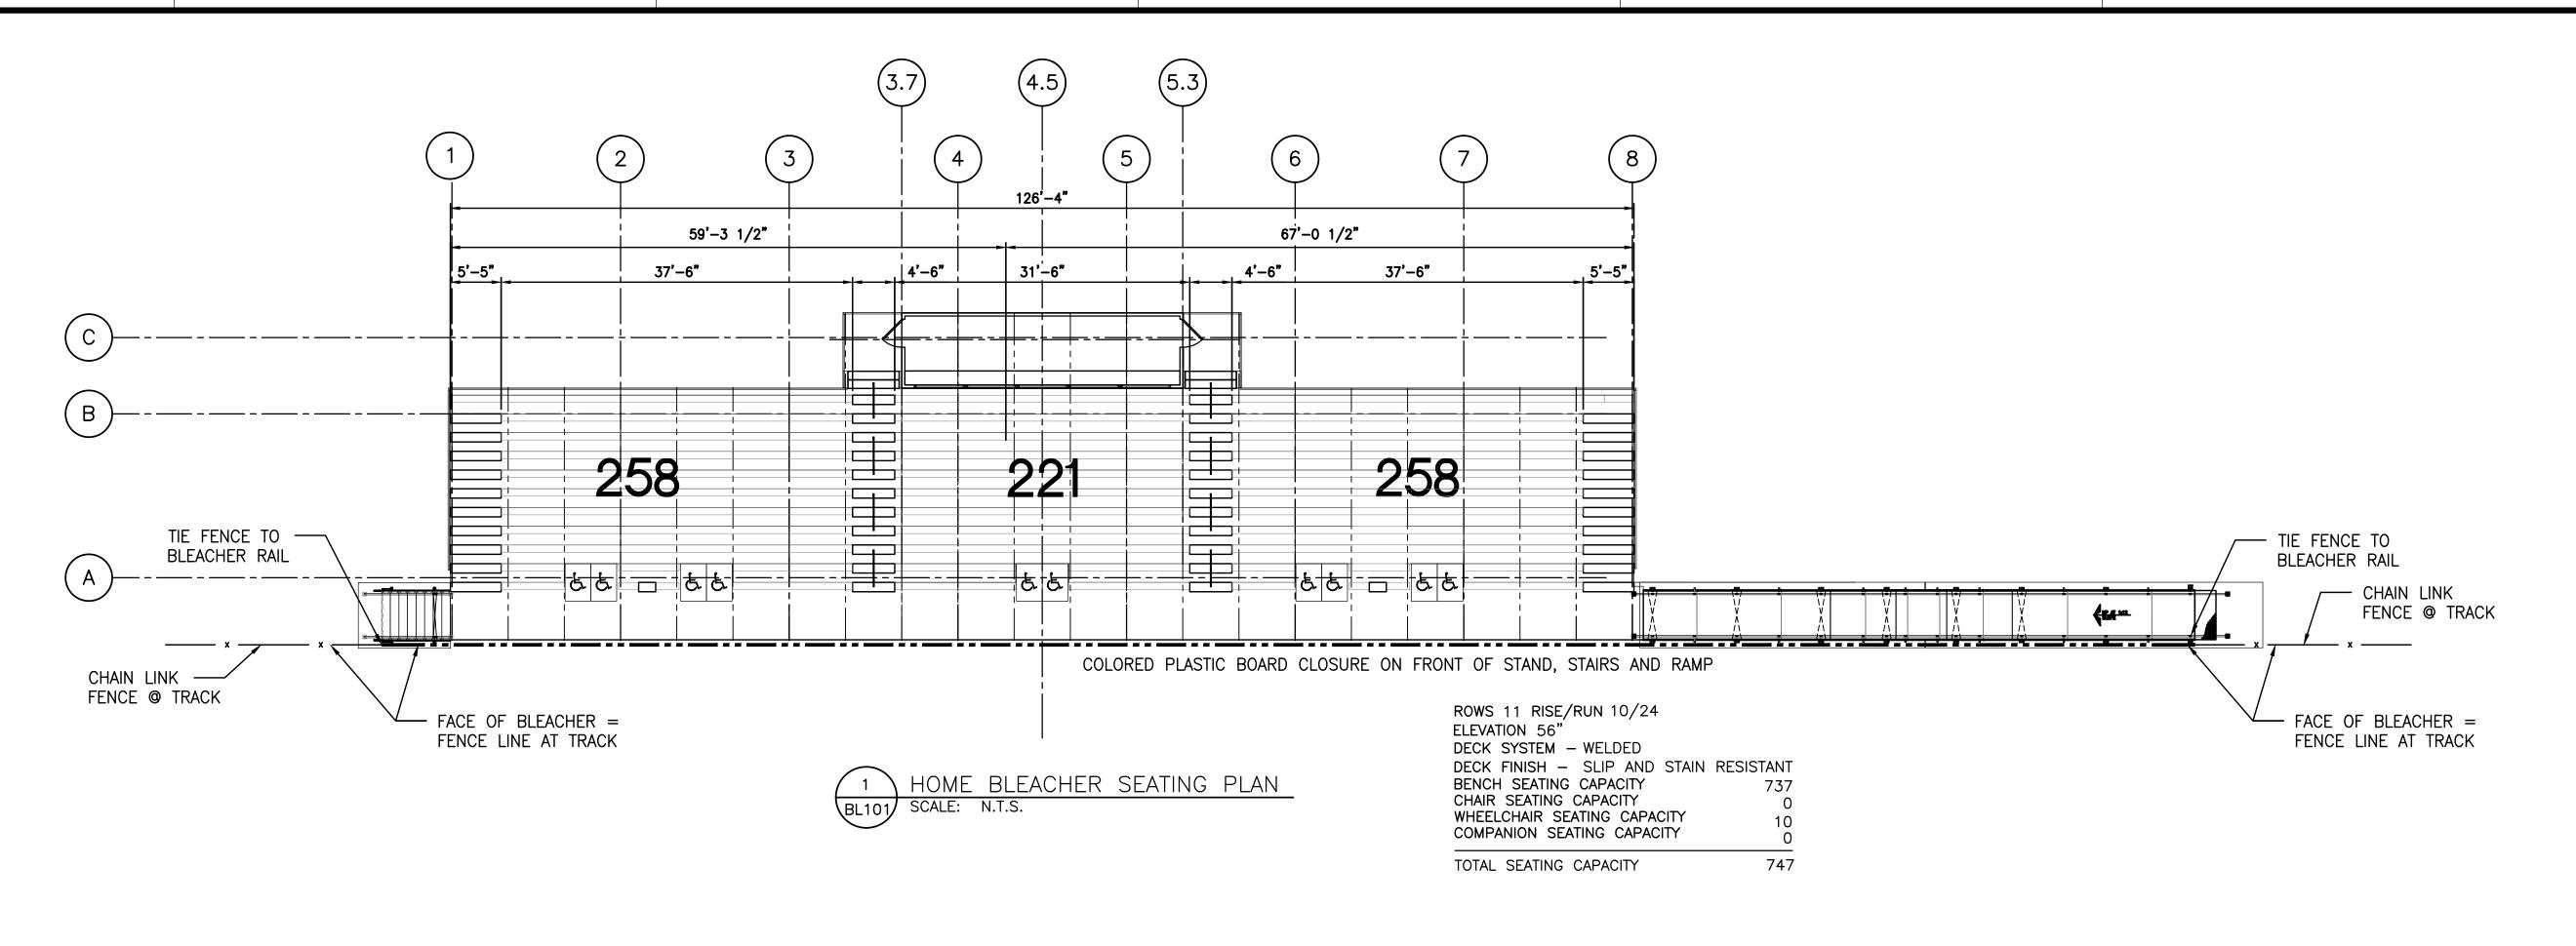

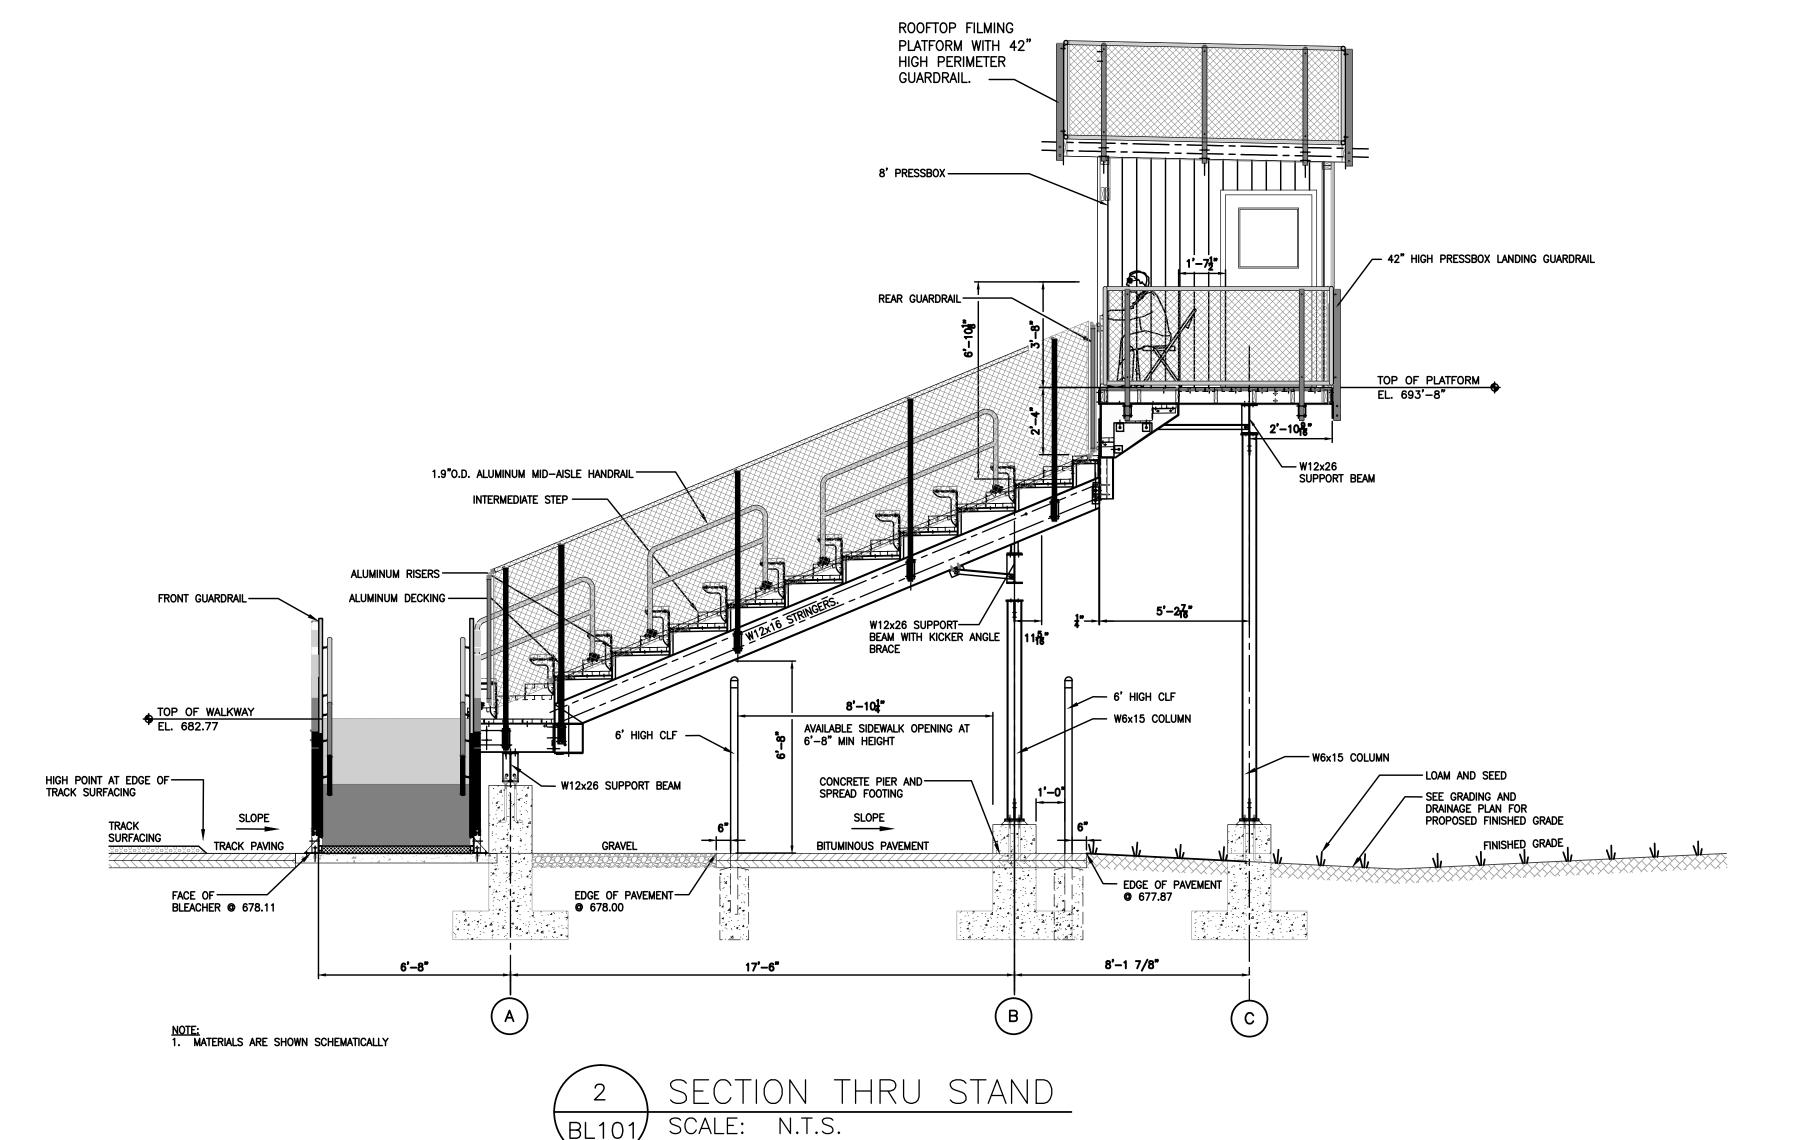

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PROJECT	TORRINGTON HIGH SCHOOL RACK AND FIELD RENOVATION PROJECT 50 MAJOR BESSE DRIVE TORRINGTON, CT	OWNER	CITY OF TORRINGTON 140 MAIN STREET TORRINGTON, CT 06790
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1	4/15/14	DIMS/	GEOTECH
CAD	D FILE		716300_BL101
DES	IGNED BY		BTC/EQR

REVISIONS

DESCRIPTION

CADD FILE	716300_BL101
DESIGNED BY	BTC/EQR
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CHECKED BY	EQR
DATE	3-28-14
DRAWING SCALE	N.T.S.
GRAPHIC	SCALE

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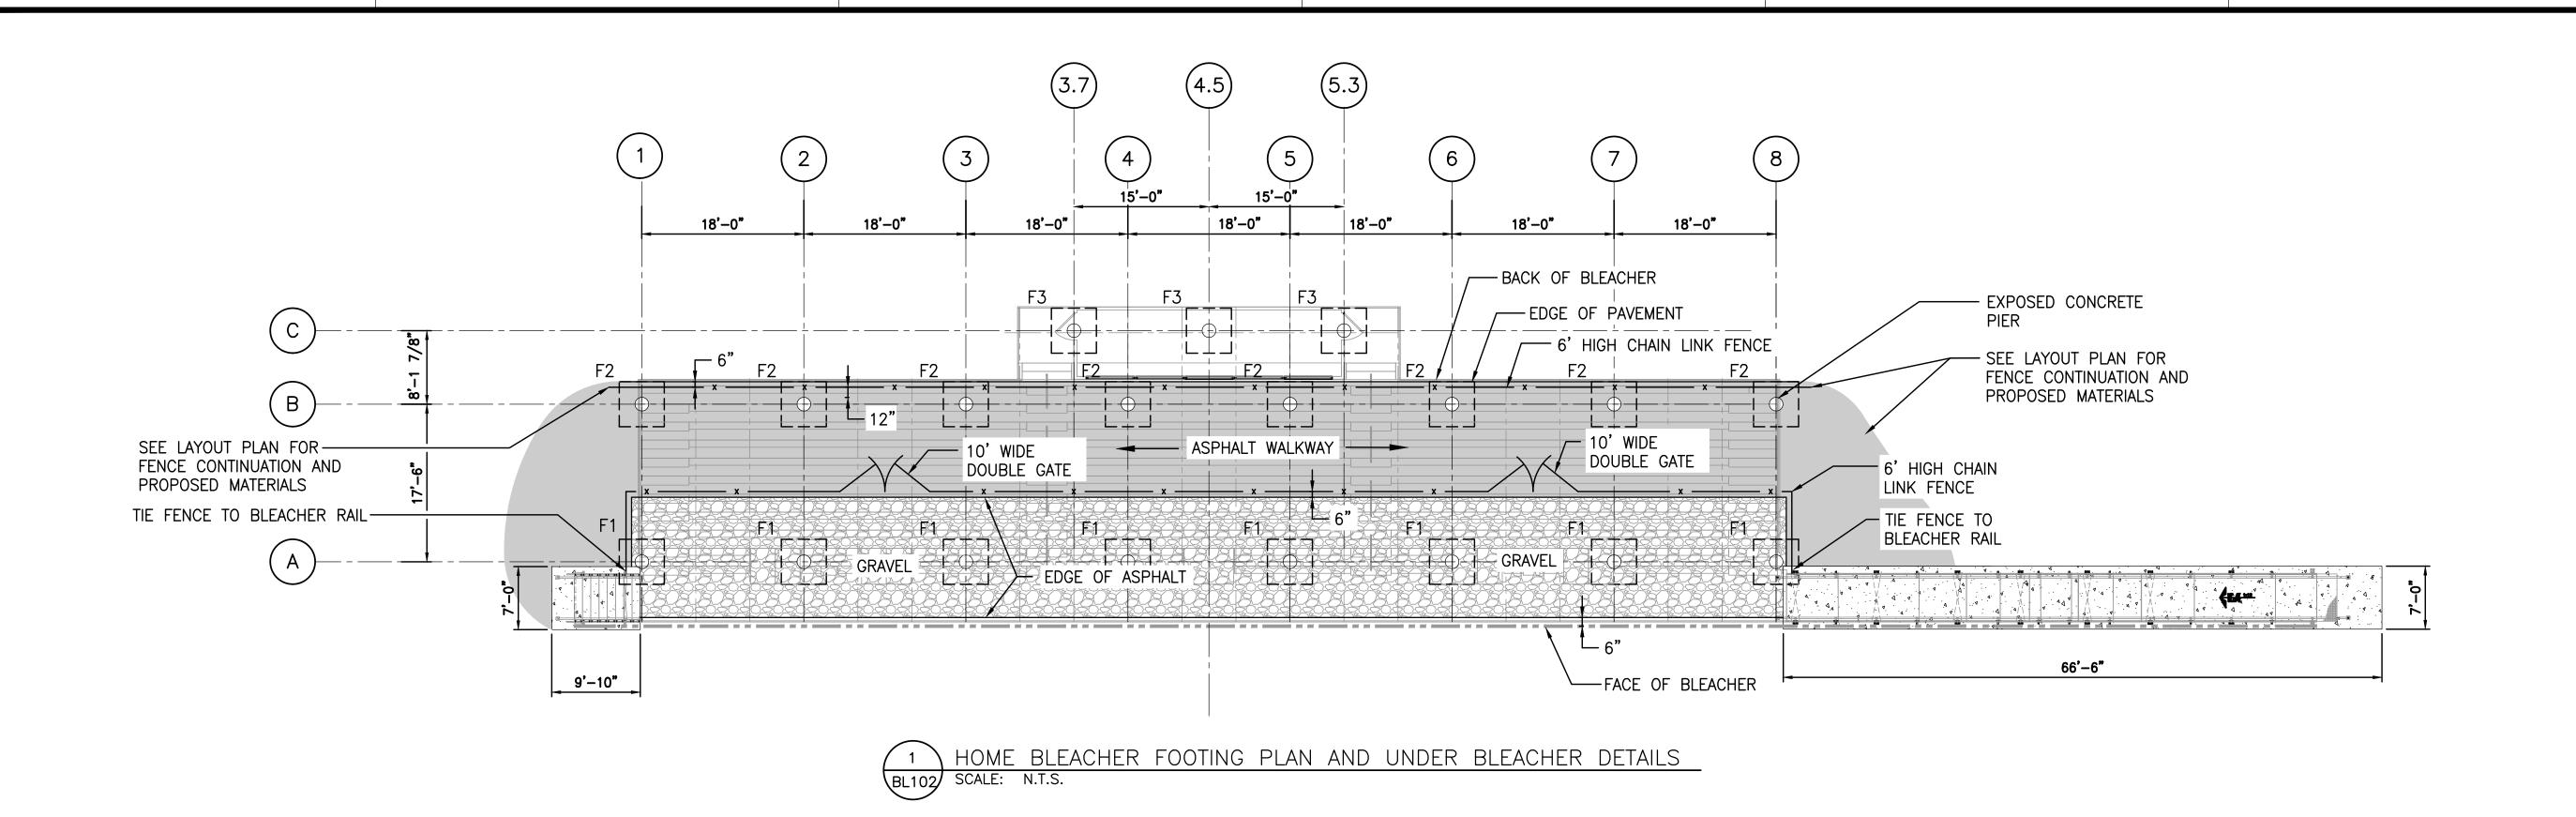
SHEET TITLE

HOME BLEACHER/ PRESS BOX LAYOUT AND SECTION PLAN

BID SET

BL101

PROJECT NO. **716300**



CLR _______ 3/4"ø X 1'-8" LG. ASTM F1554 ANCHOR

DESIGNED STEEL BEARING ELEVATION

SEE SCHEDULE FOR REINFORCEMENT

TOP OF PIER ELEV.

LEVELING NUTS

---(3) #3 IN TOP 5"

FINISH GRADE

CONCRETE PIER-

VERTICAL REBAR-

(SEE SCHEDULE)

w/ #3 TIES @

10" MAX. ON CENTER


(SEE SCHEDULE

FOR SIZING INFO)



SELECTED BLEACHER MANUFACTURER SHALL PROVIDE STAMPED ENGINEERING STRUCTURAL DESIGN DRAWINGS FOR BLEACHERS AND BLEACHER FOOTINGS (BLEACHER SYSTEM).

- 1. THE ELEVATION OF THE TOP OF THE CONCRETE PIER IS DESIGNED TO BE 1 1/2" BELOW THE STEEL BEARING ELEVATION. TOLERANCES FOR THE TOP OF CONCRETE PIER SHALL BE $\pm \pm 1/8$ ". THE CONCRETE INSTALLER IS RESPONSIBLE FOR NON-SHRINK GROUTING.
- THE TOP OF CONCRETE MAY BE RAISED TO MATCH THE STEEL BEARING ELEVATION AT THE INSTALLER'S DISCRETION. INSTALLER IS THEN RESPONSIBLE FOR ANY ADJUSTMENTS.
- 2. ALL COLUMN ANCHOR BOLTS MUST HAVE A 4" PROJECTION (+/-1/8") ABOVE THE TOP OF PIER ELEVATION. 3. MAXIMUM HORIZONTAL TOLERANCE OF ANCHOR BOLT PLACEMENT
- SHALL BE 1/8". 4. ALL UNDERGROUND UTILITIES ARE TO BE LOCATED AND MARKED DURING REVIEW PROCESS PRIOR TO FOUNDATION EXCAVATION. DANT CORP. SHALL NOT BE RESPONSIBLE FOR DAMAGE TO UNDERGROUND
- 5. REFERENCE GEOTECHNICAL REPORT FOR MINIMUM FOOTING DEPTH AND SOIL BEARING PRESSURE.

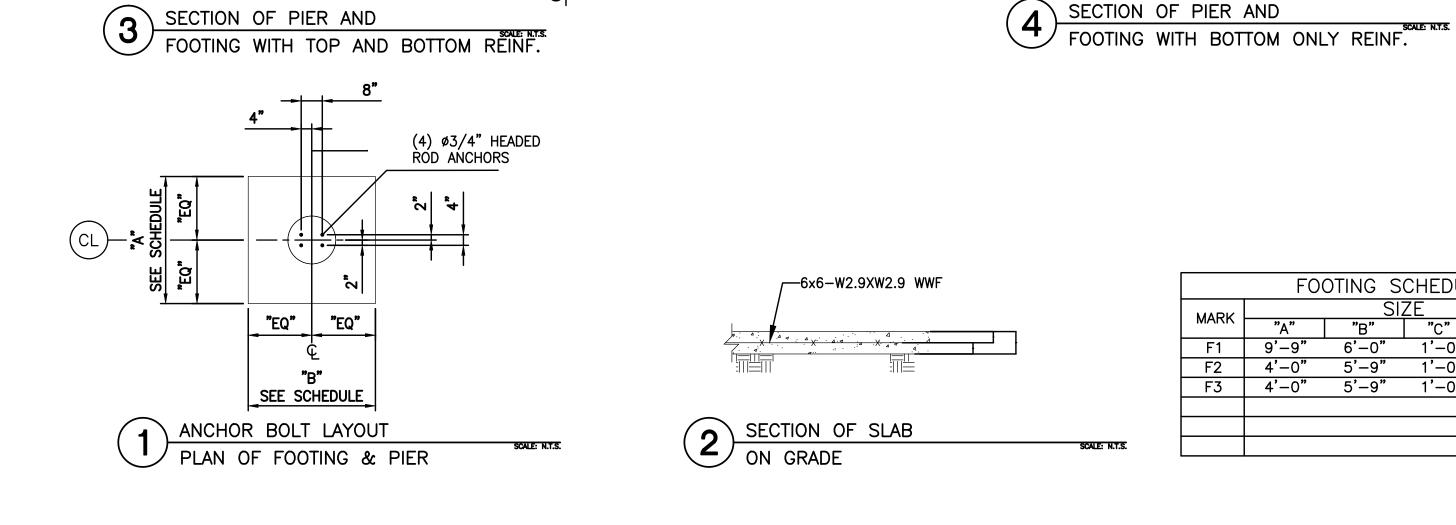

1½" (NOM.) 2" (MAX.) NON-SHRINK GROUT.

DESIGNED STEEL BEARING ELEVATION

SEE SCHEDULE FOR REINFORCEMENT

——(3) #3 IN TOP 5"

FINISH GRADE

CONCRETE PIER -(SEE SCHEDULE FOR SIZING INFO)

VERTICAL REBAR —

10" MAX. ON CENTER

(SEE SCHEDULE)

w/ #3 TIES @

#5 @ 12"—— O.C. E.W. TOP

FOOTING SCHEDULE				PIER SCHEDULE							
MARK	"A"	"B"	ZE "c"	"D"	REINFORCEMENT	TOP OF PIER	SIZE	REINFORCING	# OF ANCHORS	SIZE OF ANCHORS	ANCHOR BOLT TEMPLATE NO.
F1	9'-9"	6'-0"	1'-0"	3'-6"	#5@12"O.C.	28" ABOVE GRADE	24"ø	6 #6 BARS	4	3/4" x 1'-8" HEAVY HEX HEADED, ASTM F1554 GR. 55	0055517
F2	4'-0"	5'-9"	1'-0"	3'-6"	#5@12"O.C.	12" ABOVE GRADE	18"ø	6 #5 BARS	4	3/4" x 1'-8" HEAVY HEX HEADED, ASTM F1554 GR. 55	0055517
F3	4'-0"	5'-9"	1'-0"	3'-6"	#5@12"O.C.	12" ABOVE GRADE	18"ø	6 #5 BARS	4	3/4" x 1'-8" HEAVY HEX HEADED, ASTM F1554 GR. 55	0055517
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SOIL BEARING CAPACITY - 4000 PSF





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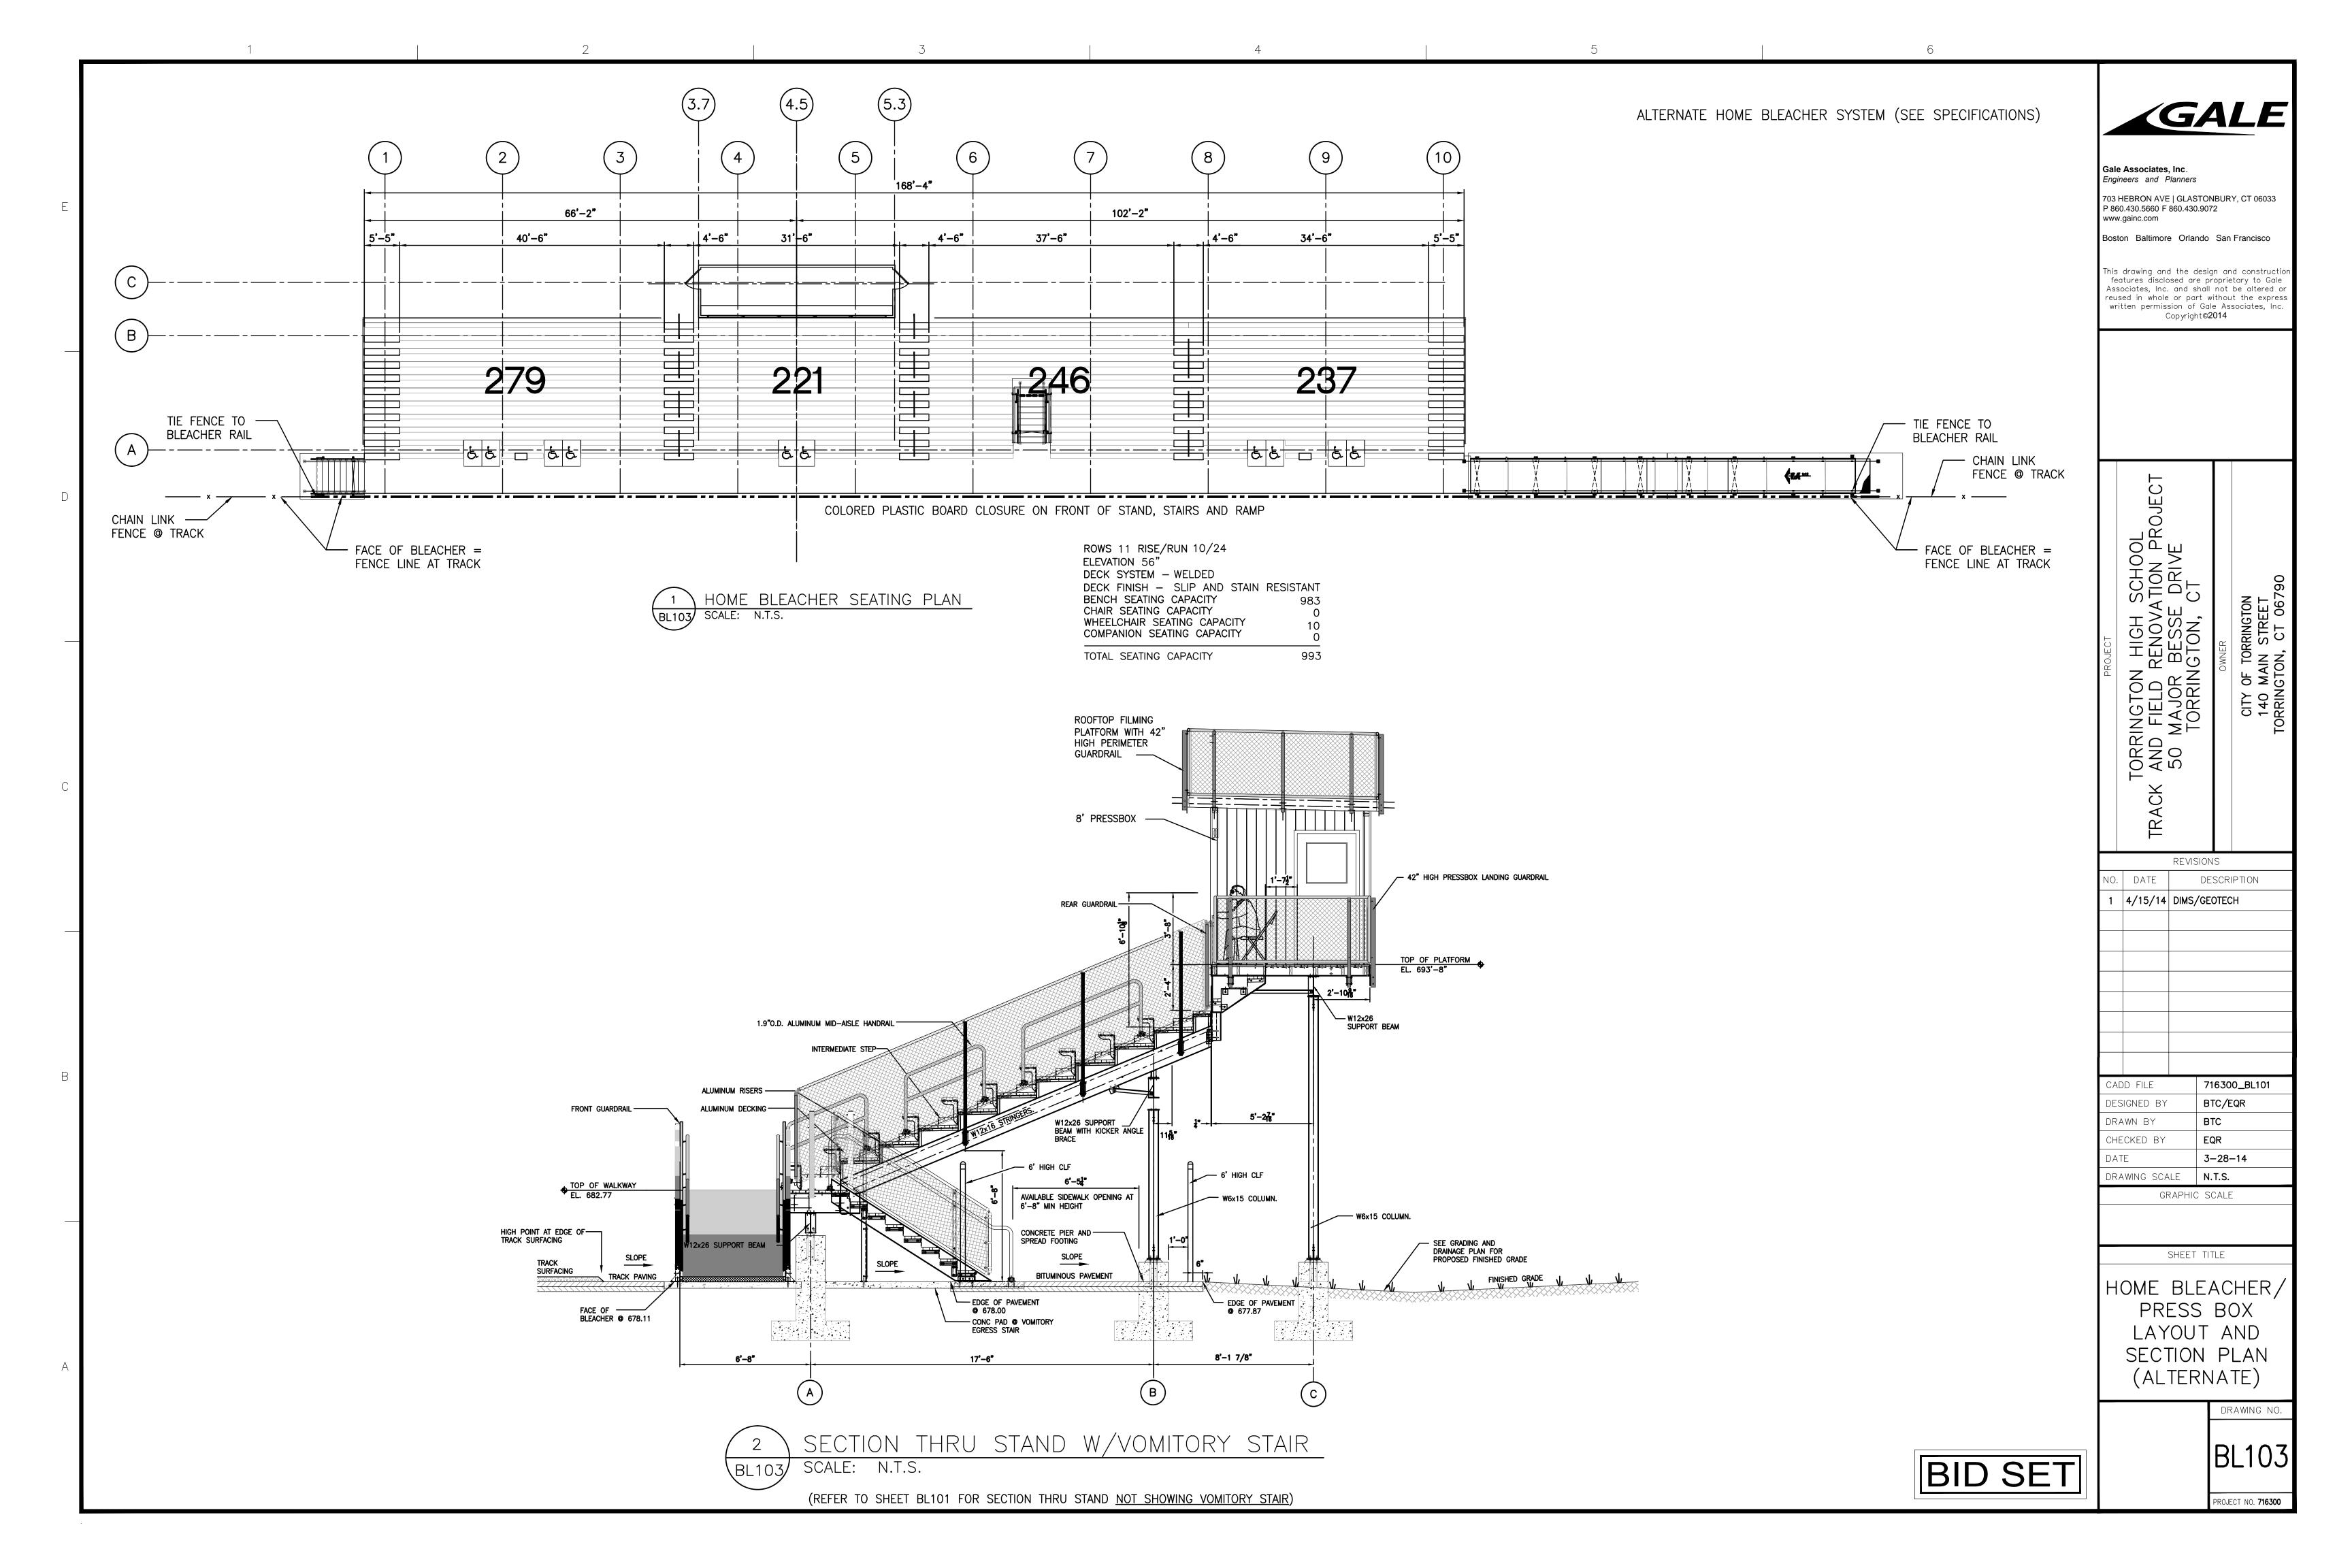
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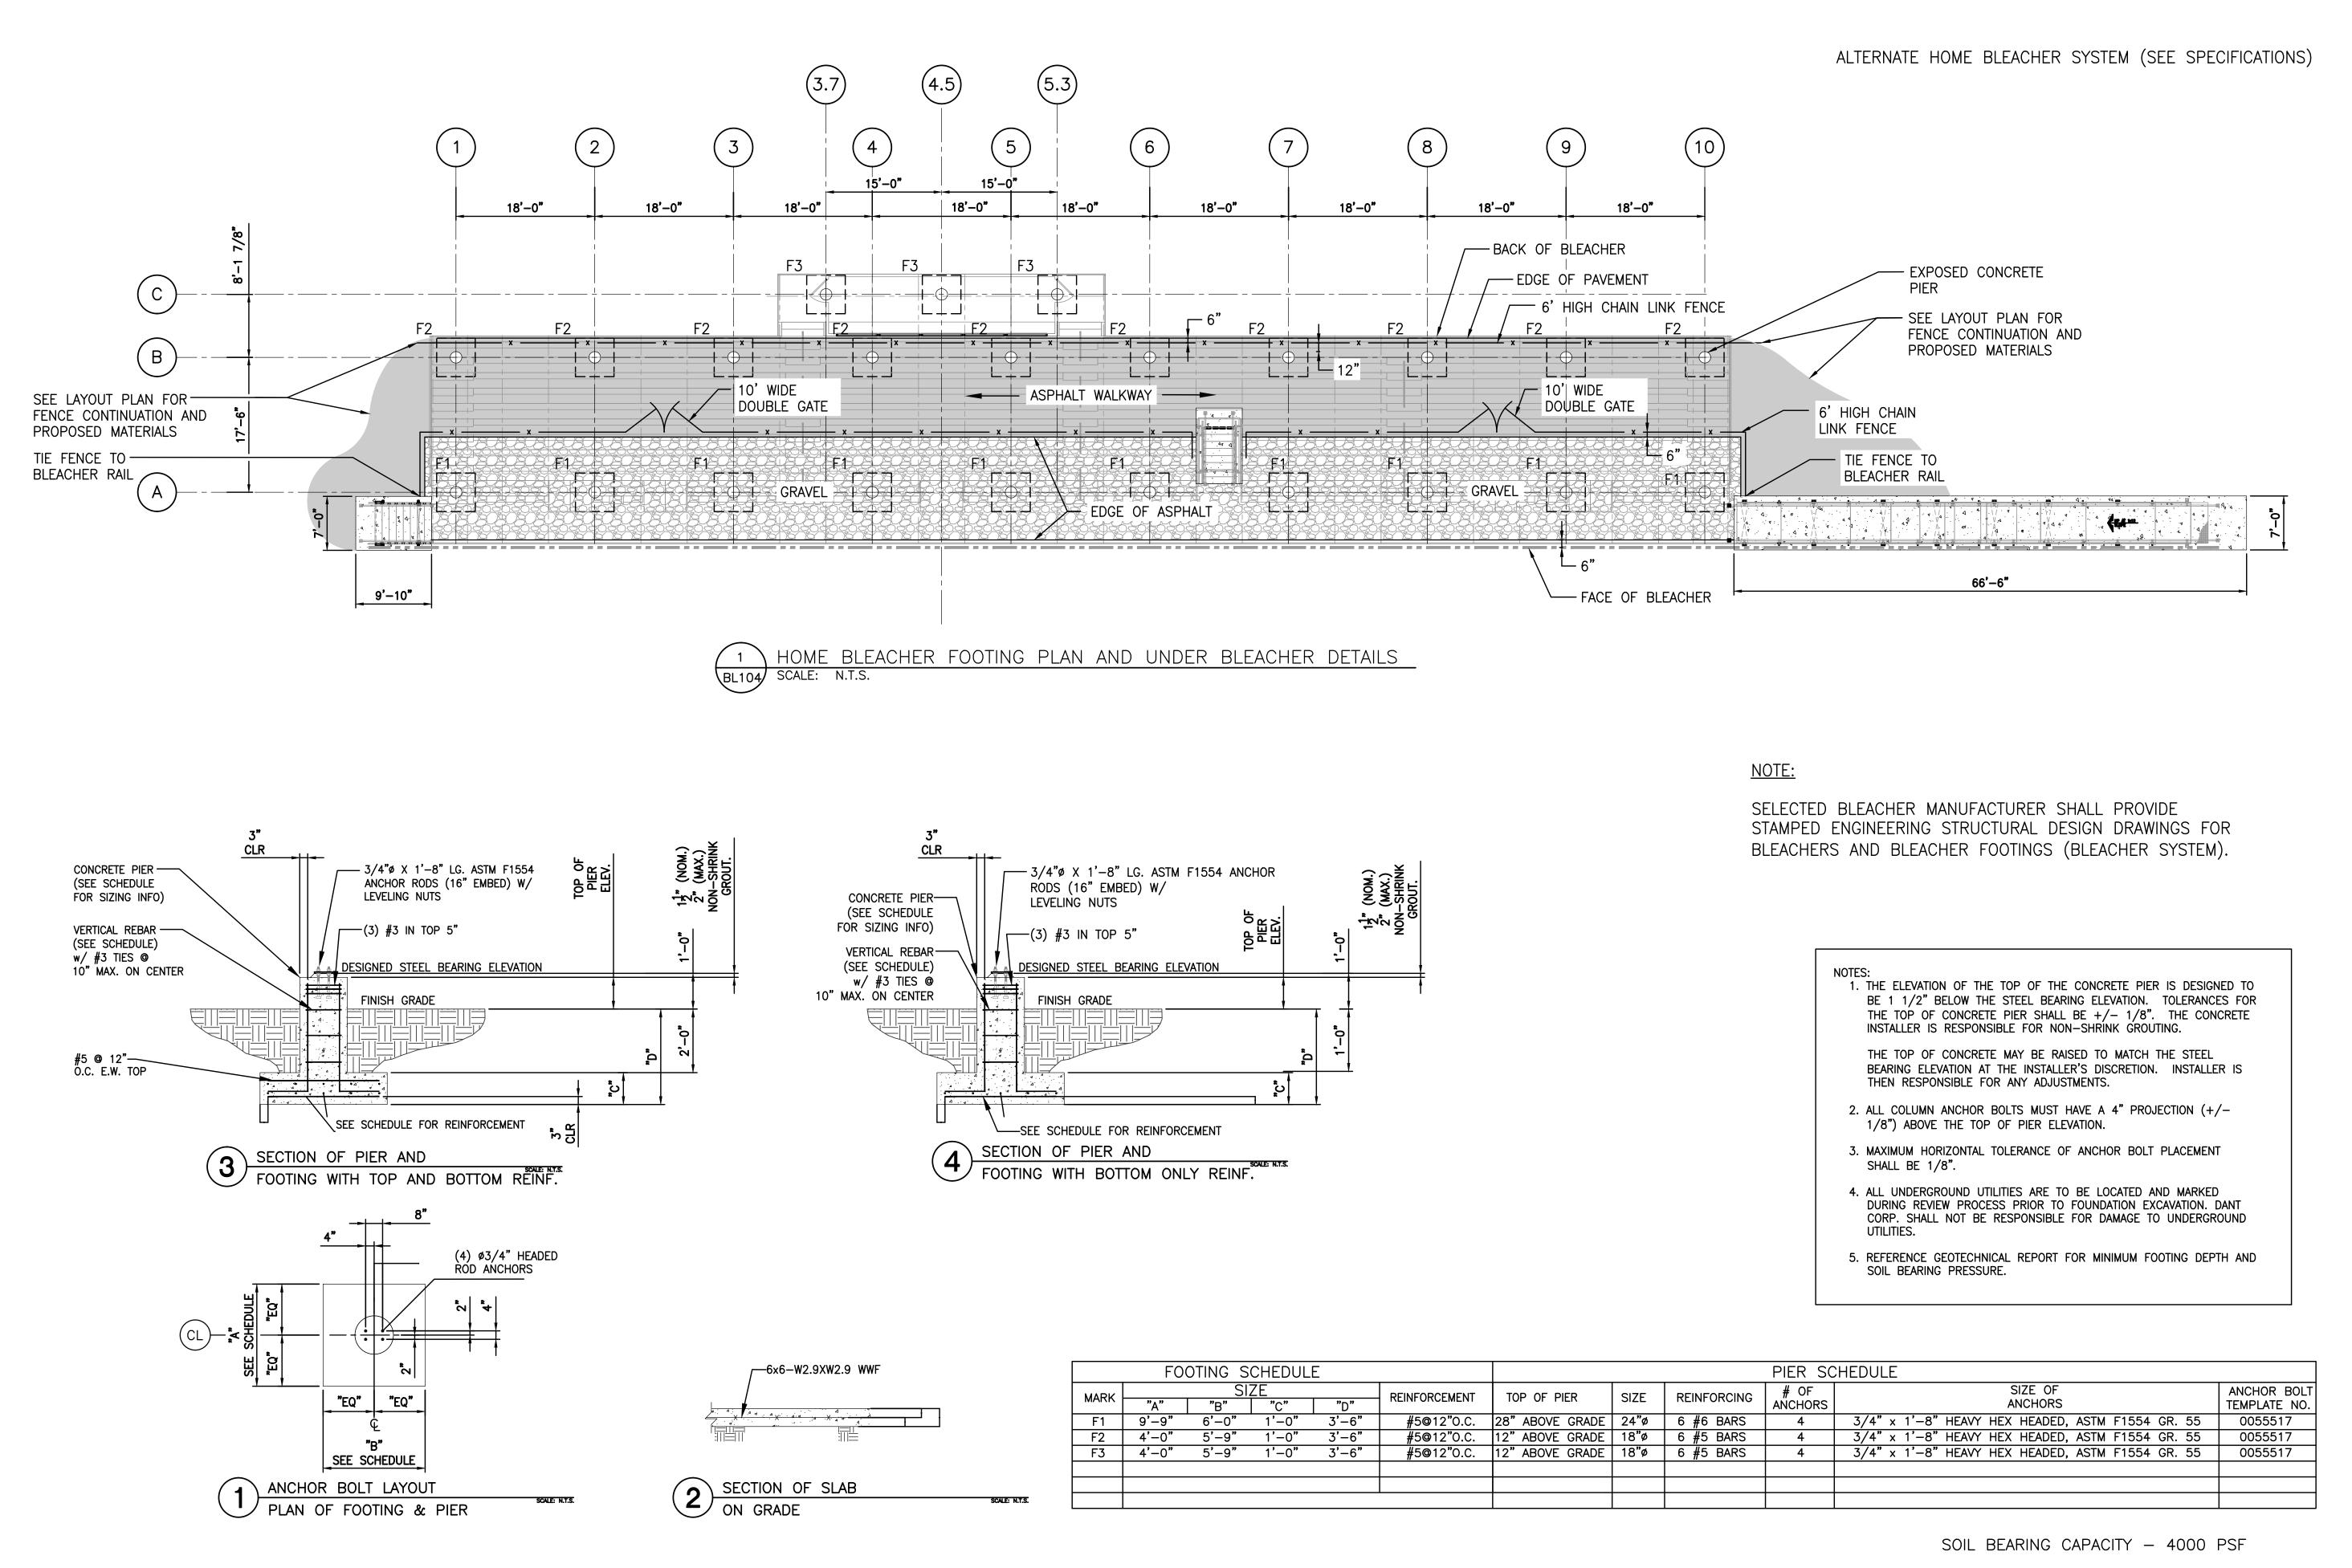
HOME BLEACHER/ PRESS BOX LAYOUT AND SECTION PLAN

SHEET TITLE

DRAWING NO. BL102

PROJECT NO. **716300**





BID SET

GALE

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TORRINGTON HIGH SCHOOL RACK AND FIELD RENOVATION PR 50 MAJOR BESSE DRIVE TORRINGTON, CT OWNER 140 MAIN STREET	CETAIN TO MOTOR TO	140 MAIN STREET	CITY OF TORRINGTON	OWNER	TRACK AND FIELD RENOVATION PROJECT 50 MAJOR BESSE DRIVE TORRINGTON, CT	PROJECT	
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DESIGNED BY			BTC/E	QR
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DATE	3-28-14
DRAWING SCALE	N.T.S.

GRAPHIC SCALE


HOME BLEACHER/ PRESS BOX FOUNDATION AND


SHEET TITLE

FOUNDATION AN DETAILS PLAN (ALTERNATE)

DRAWING NO.

BL104
PROJECT NO. 716300

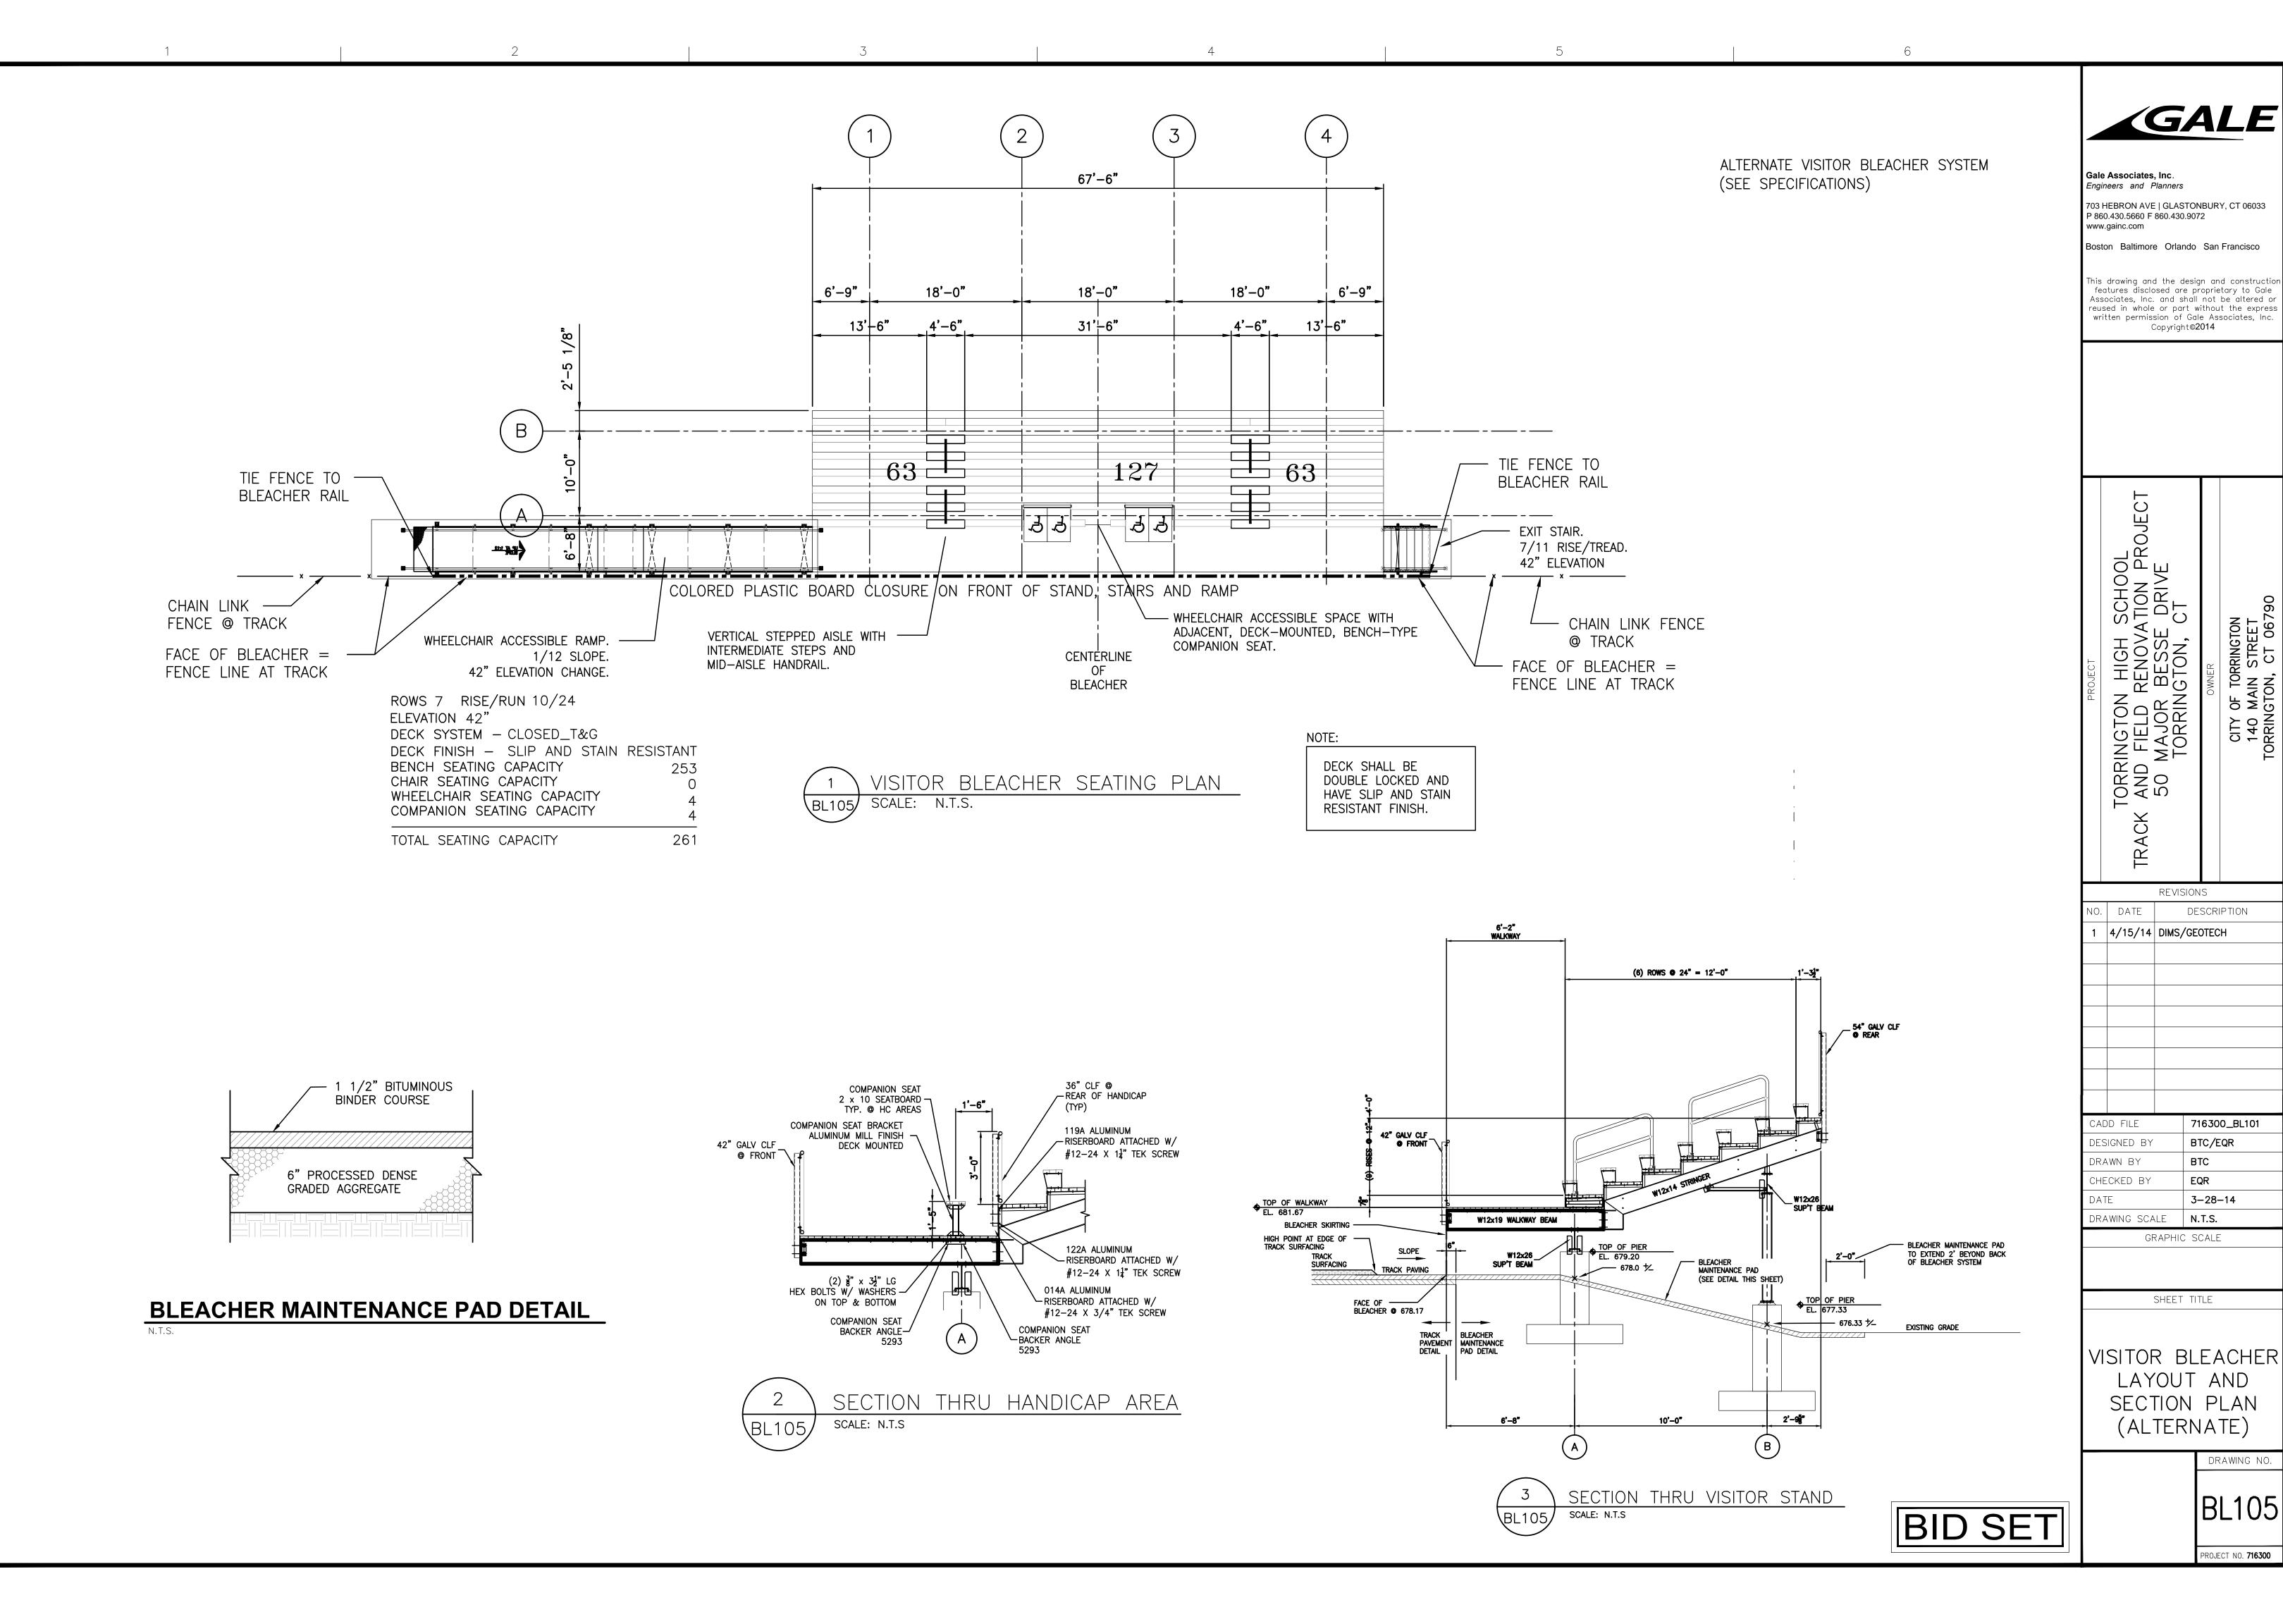

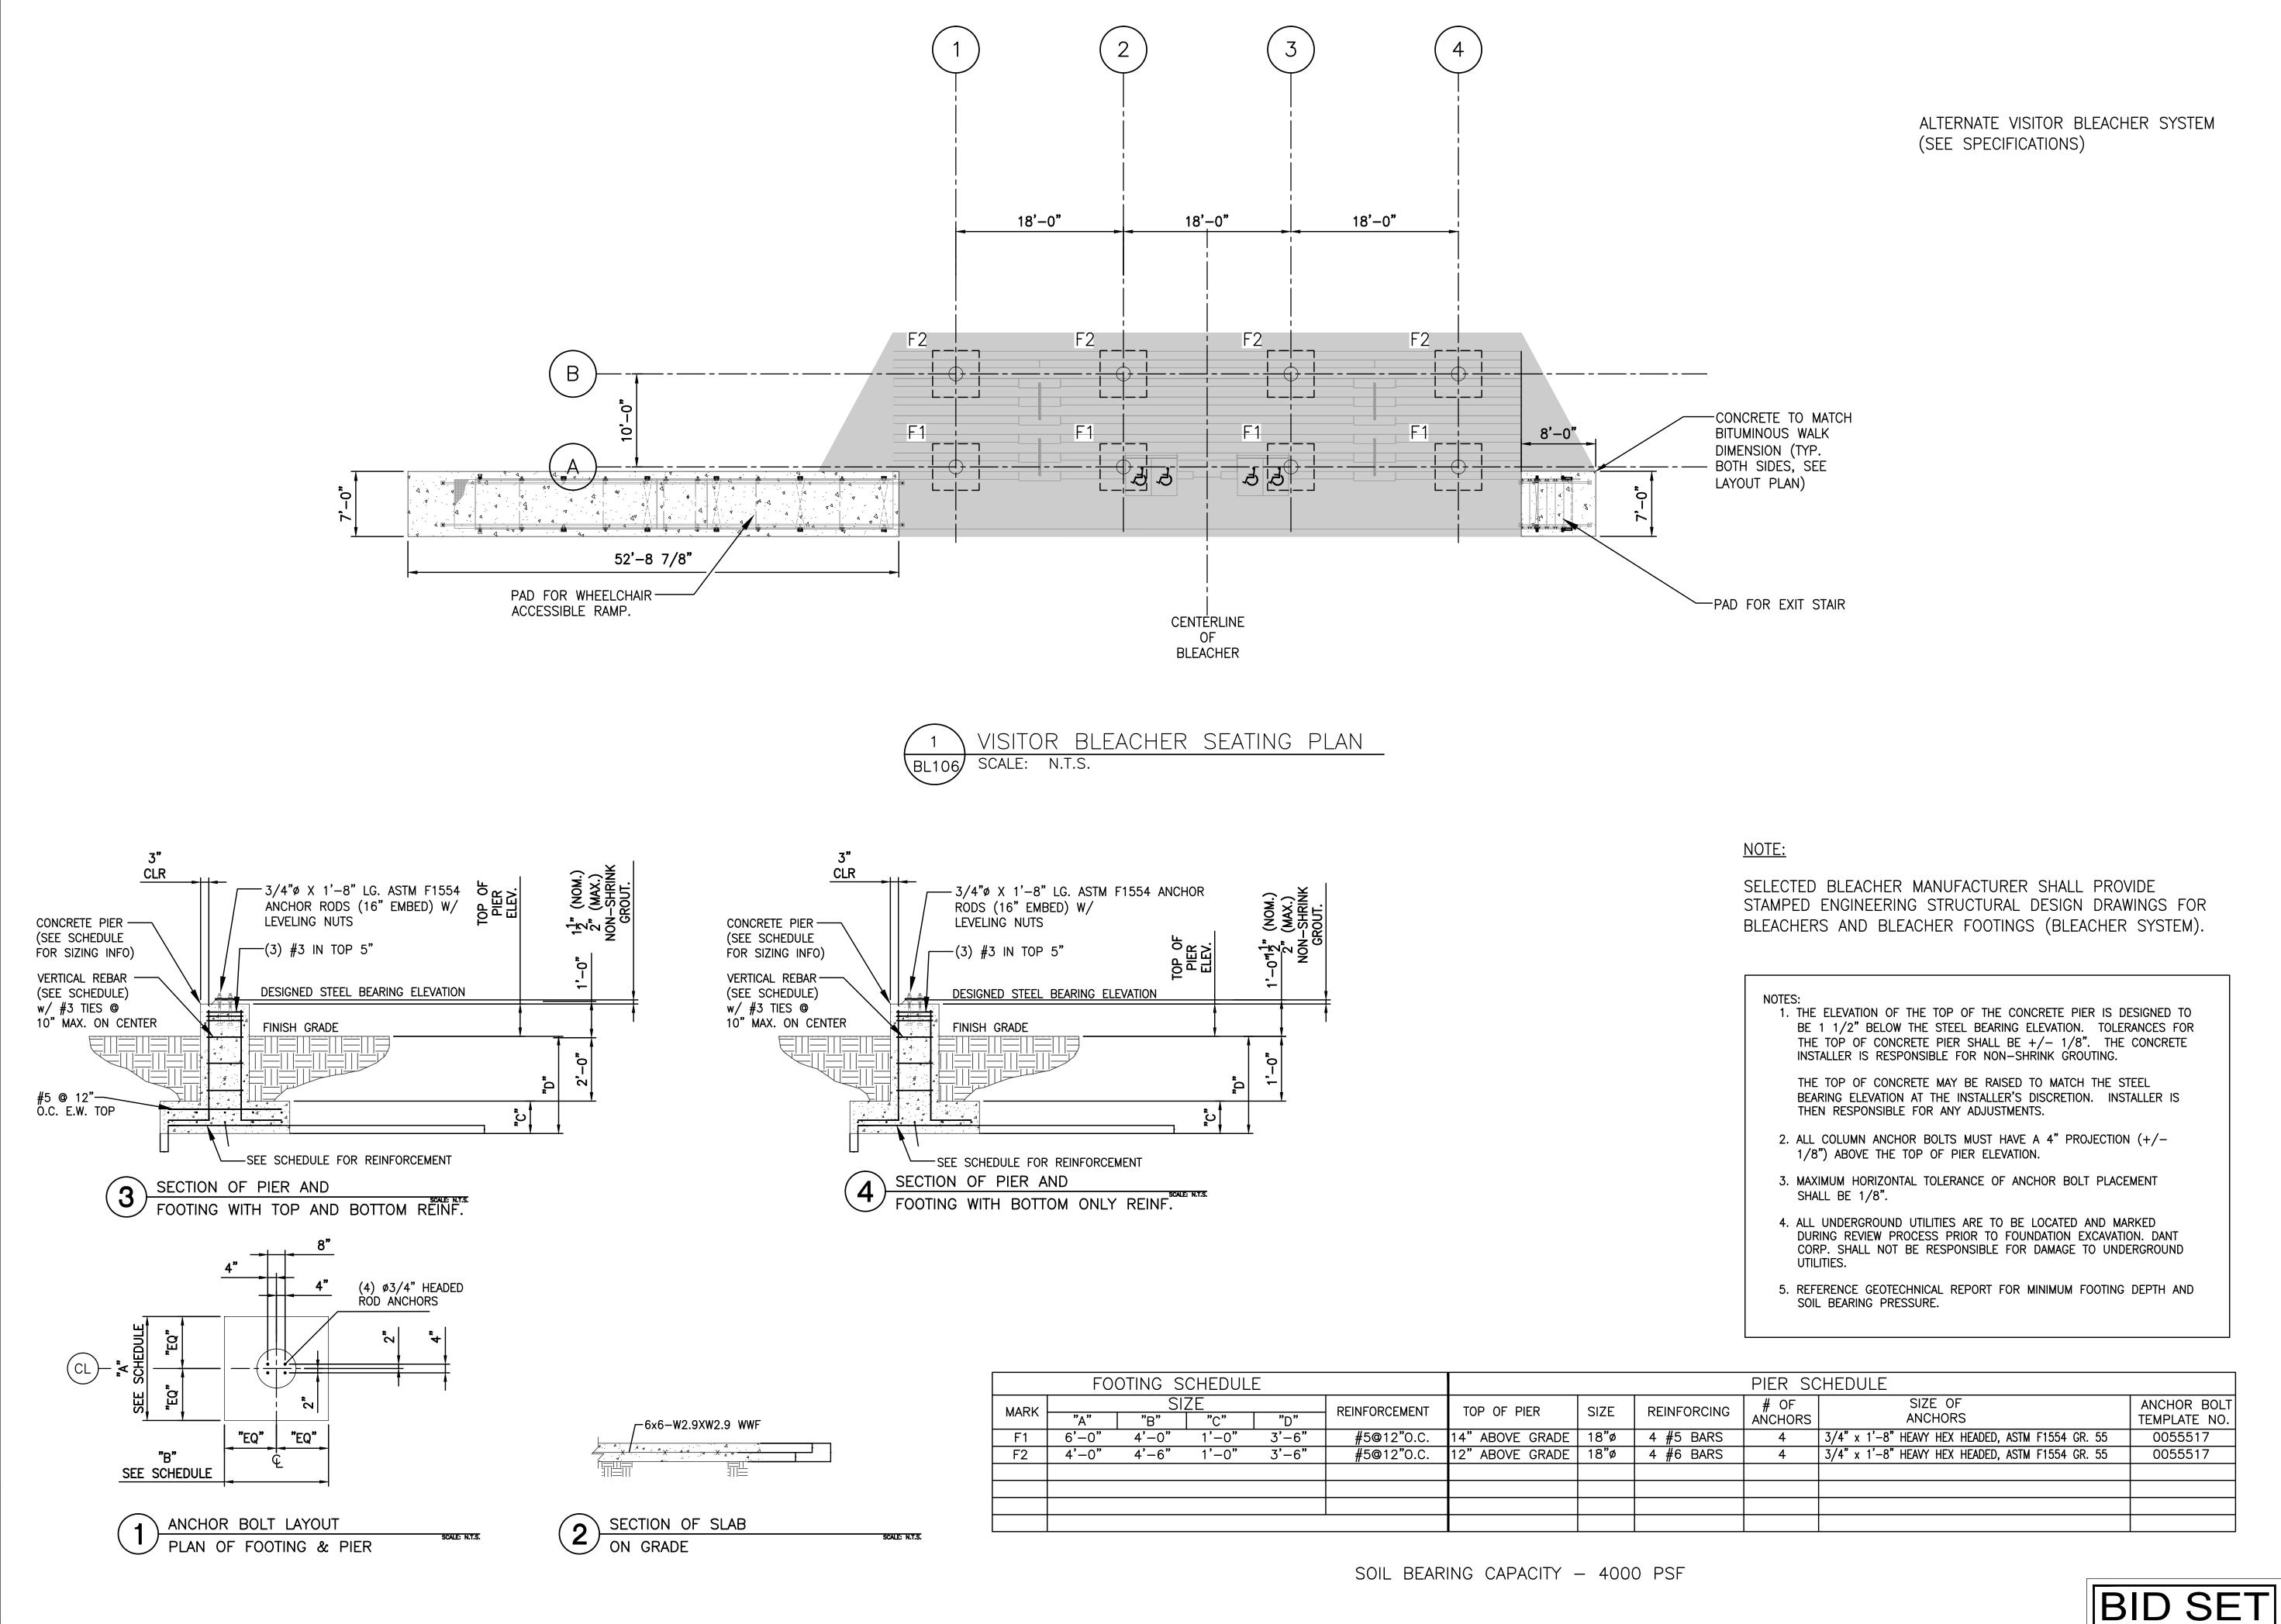

GALE

Gale Associates, Inc.
Engineers and Planners

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REVISIONS

NO. DATE DESCRIPTION

1 4/15/14 DIMS/GEOTECH

CADD FILE 716300_BL101

DESIGNED BY BTC/EQR

DRAWN BY BTC

CHECKED BY EQR

DATE 3-28-14

DRAWING SCALE N.T.S.

GRAPHIC SCALE

SHEET TITLE

VISITOR BLEACHER FOUNDATION AND DETAILS PLAN (ALTERNATE)

DRAWING NO.

BL106
PROJECT NO. 716300