C H R I S T I N A G R I F F I N A R C H I T E C T_{PC} 10 Spring Street, Hastings-on-Hudson, New York 10706

September 16, 2015

Members of the Hastings Zoning Board of Appeals Village of Hastings-on-Hudson 7 Maple Avenue Hastings-on-Hudson, NY 10706

Re:

Renovations & Extensions to the Bowen-Rink Residence 1 Flower Avenue, Hastings-on-Hudson, NY

To the Members of the Zoning Board of Appeals:

As the Architect representing David Bowen and Bennett Rink, I am submitting the following drawings, dated September 11, 2015:

Title Sheet S-1 Site Plan, Zoning Compliance, Location Map S-2 View of Property, View of Neighboring Properties A-1 First Floor Plan & Second Floor Plan A-2 Exterior Elevations Survey

We are requesting that the Zoning Board of Appeals grant the following variances from the Hastings Zoning Code:

1. Variance from Section 295-68F. 1a – Front Yard Setback

We are requesting a variance for a 21.1 ft. front yard setback, which is 8.8 ft. closer to the property line than the 30 ft. minimum front yard setback required by the Hastings Zoning Code. The existing front yard setback is 25.7 ft., and due to the triangular-shaped lot, the addition encroaches further into the front yard.

2. Variance from Section 295-68F. 1b – Rear Yard Setback

We are requesting a variance for a 6.9 FT rear yard setback, which is 23.1 FT closer to the property line than the 30 FT minimum rear yard setback required by the Hastings Zoning Code. The existing rear yard setback is 14 FT, and due to the triangular-shaped lot, the addition encroaches further into to the rear yard.

3. Variance from Section 295-20.C2 – No Paving in Required Yards

We are requesting a variance to extend the existing stone patio. The existing patio and the proposed extension to the patio are in the minimum rear yard setback.


The undersized lot area of 8,949 sf (10,000 sf minimum required by the Hastings Zoning Code) and its triangular shape create a hardship in expanding the house to meet the required setbacks. The total existing floor area is only 1,674 sf, and the owners would like to expand the home to meet the growing needs of their family. The addition increases the floor area to 2,364 sf, while keeping the footprint at 14.6% of the lot area (25% maximum required by the Hastings Zoning Code). The proposed addition is designed to be in keeping with the style, character and scale of the existing home, including keeping the second floor within the roof line to minimize bulk.

I appreciate your understanding of our request for these variances, and look forward to presenting the drawings at the next Zoning Board of Appeals meeting. Thank you for your time and effort for review of our proposal.


Sincerely,

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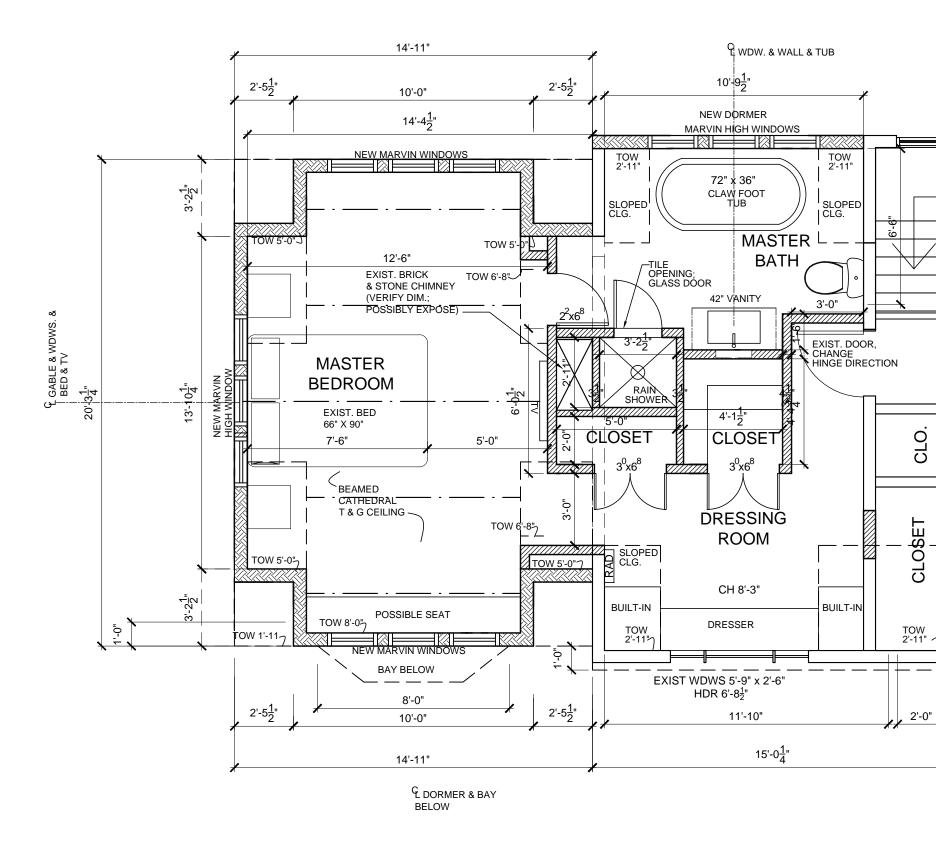
Christina Griffin AIA LEED AP CPHC

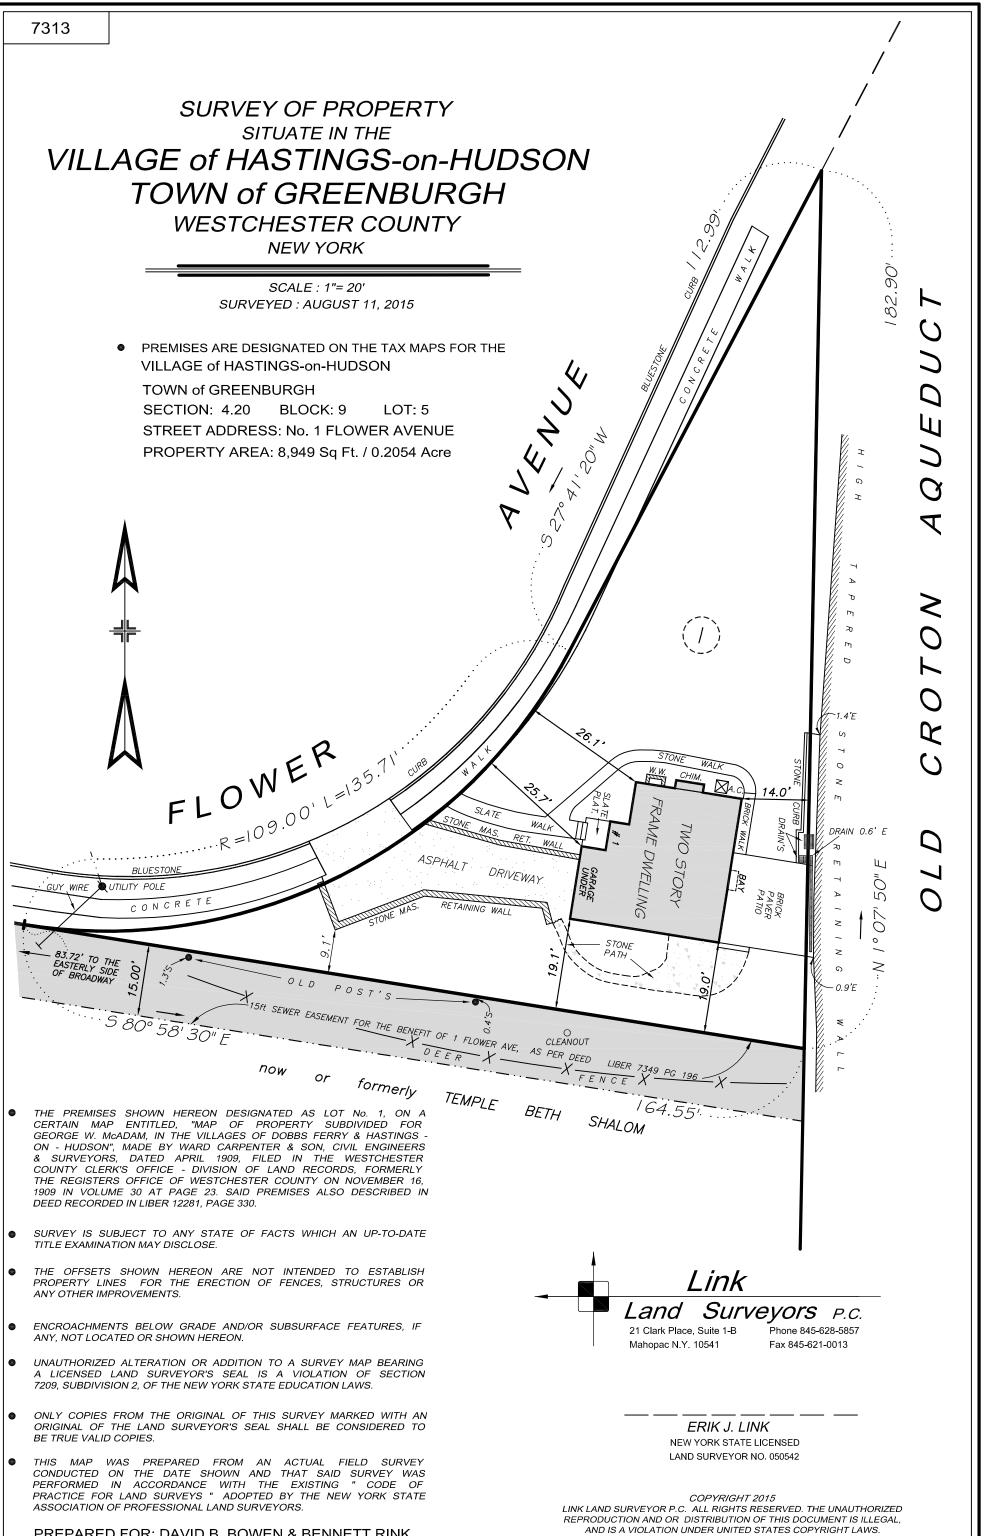

PREPARED FOR: DAVID B. BOWEN & BENNETT RINK

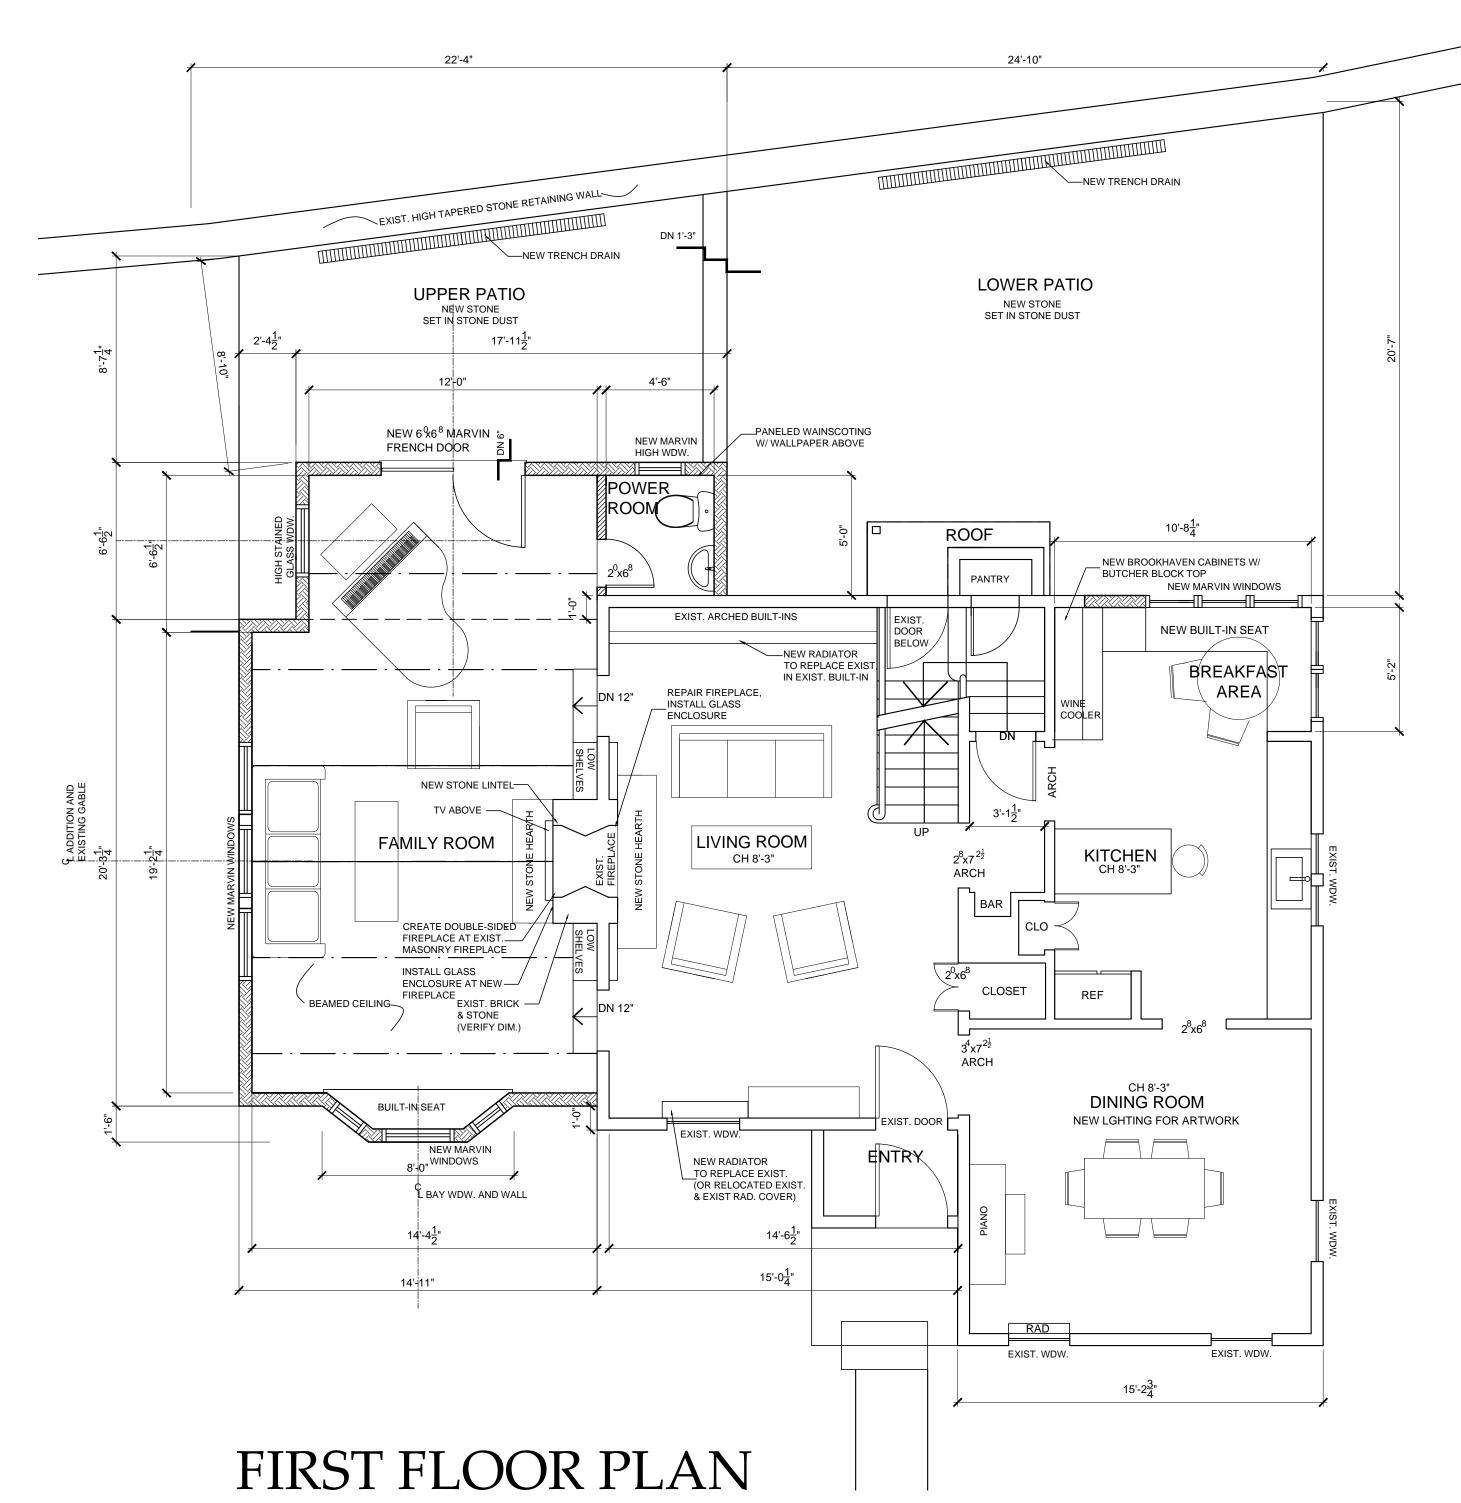



SCALE: 1/4" = 1'-0"




SCALE: 1/4" = 1'-0"

SECOND FLOOR PLAN

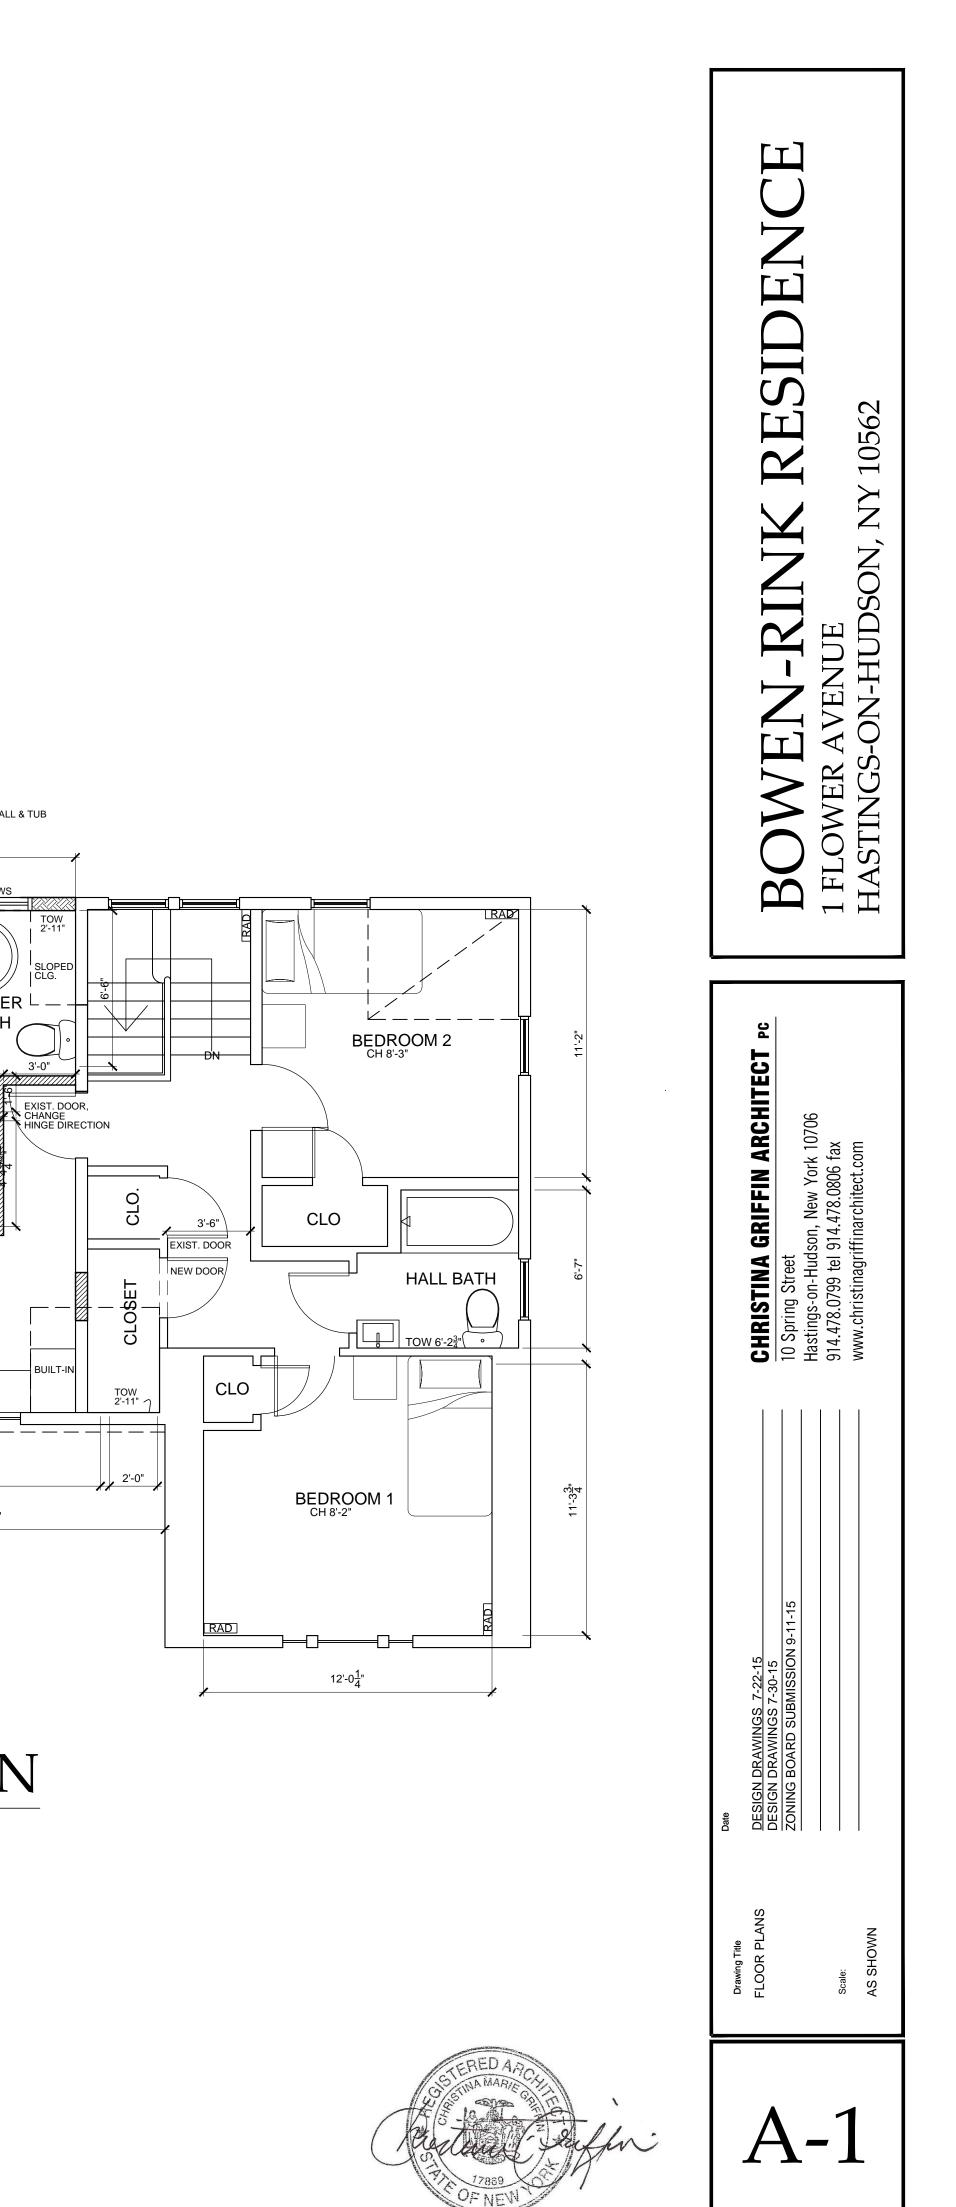


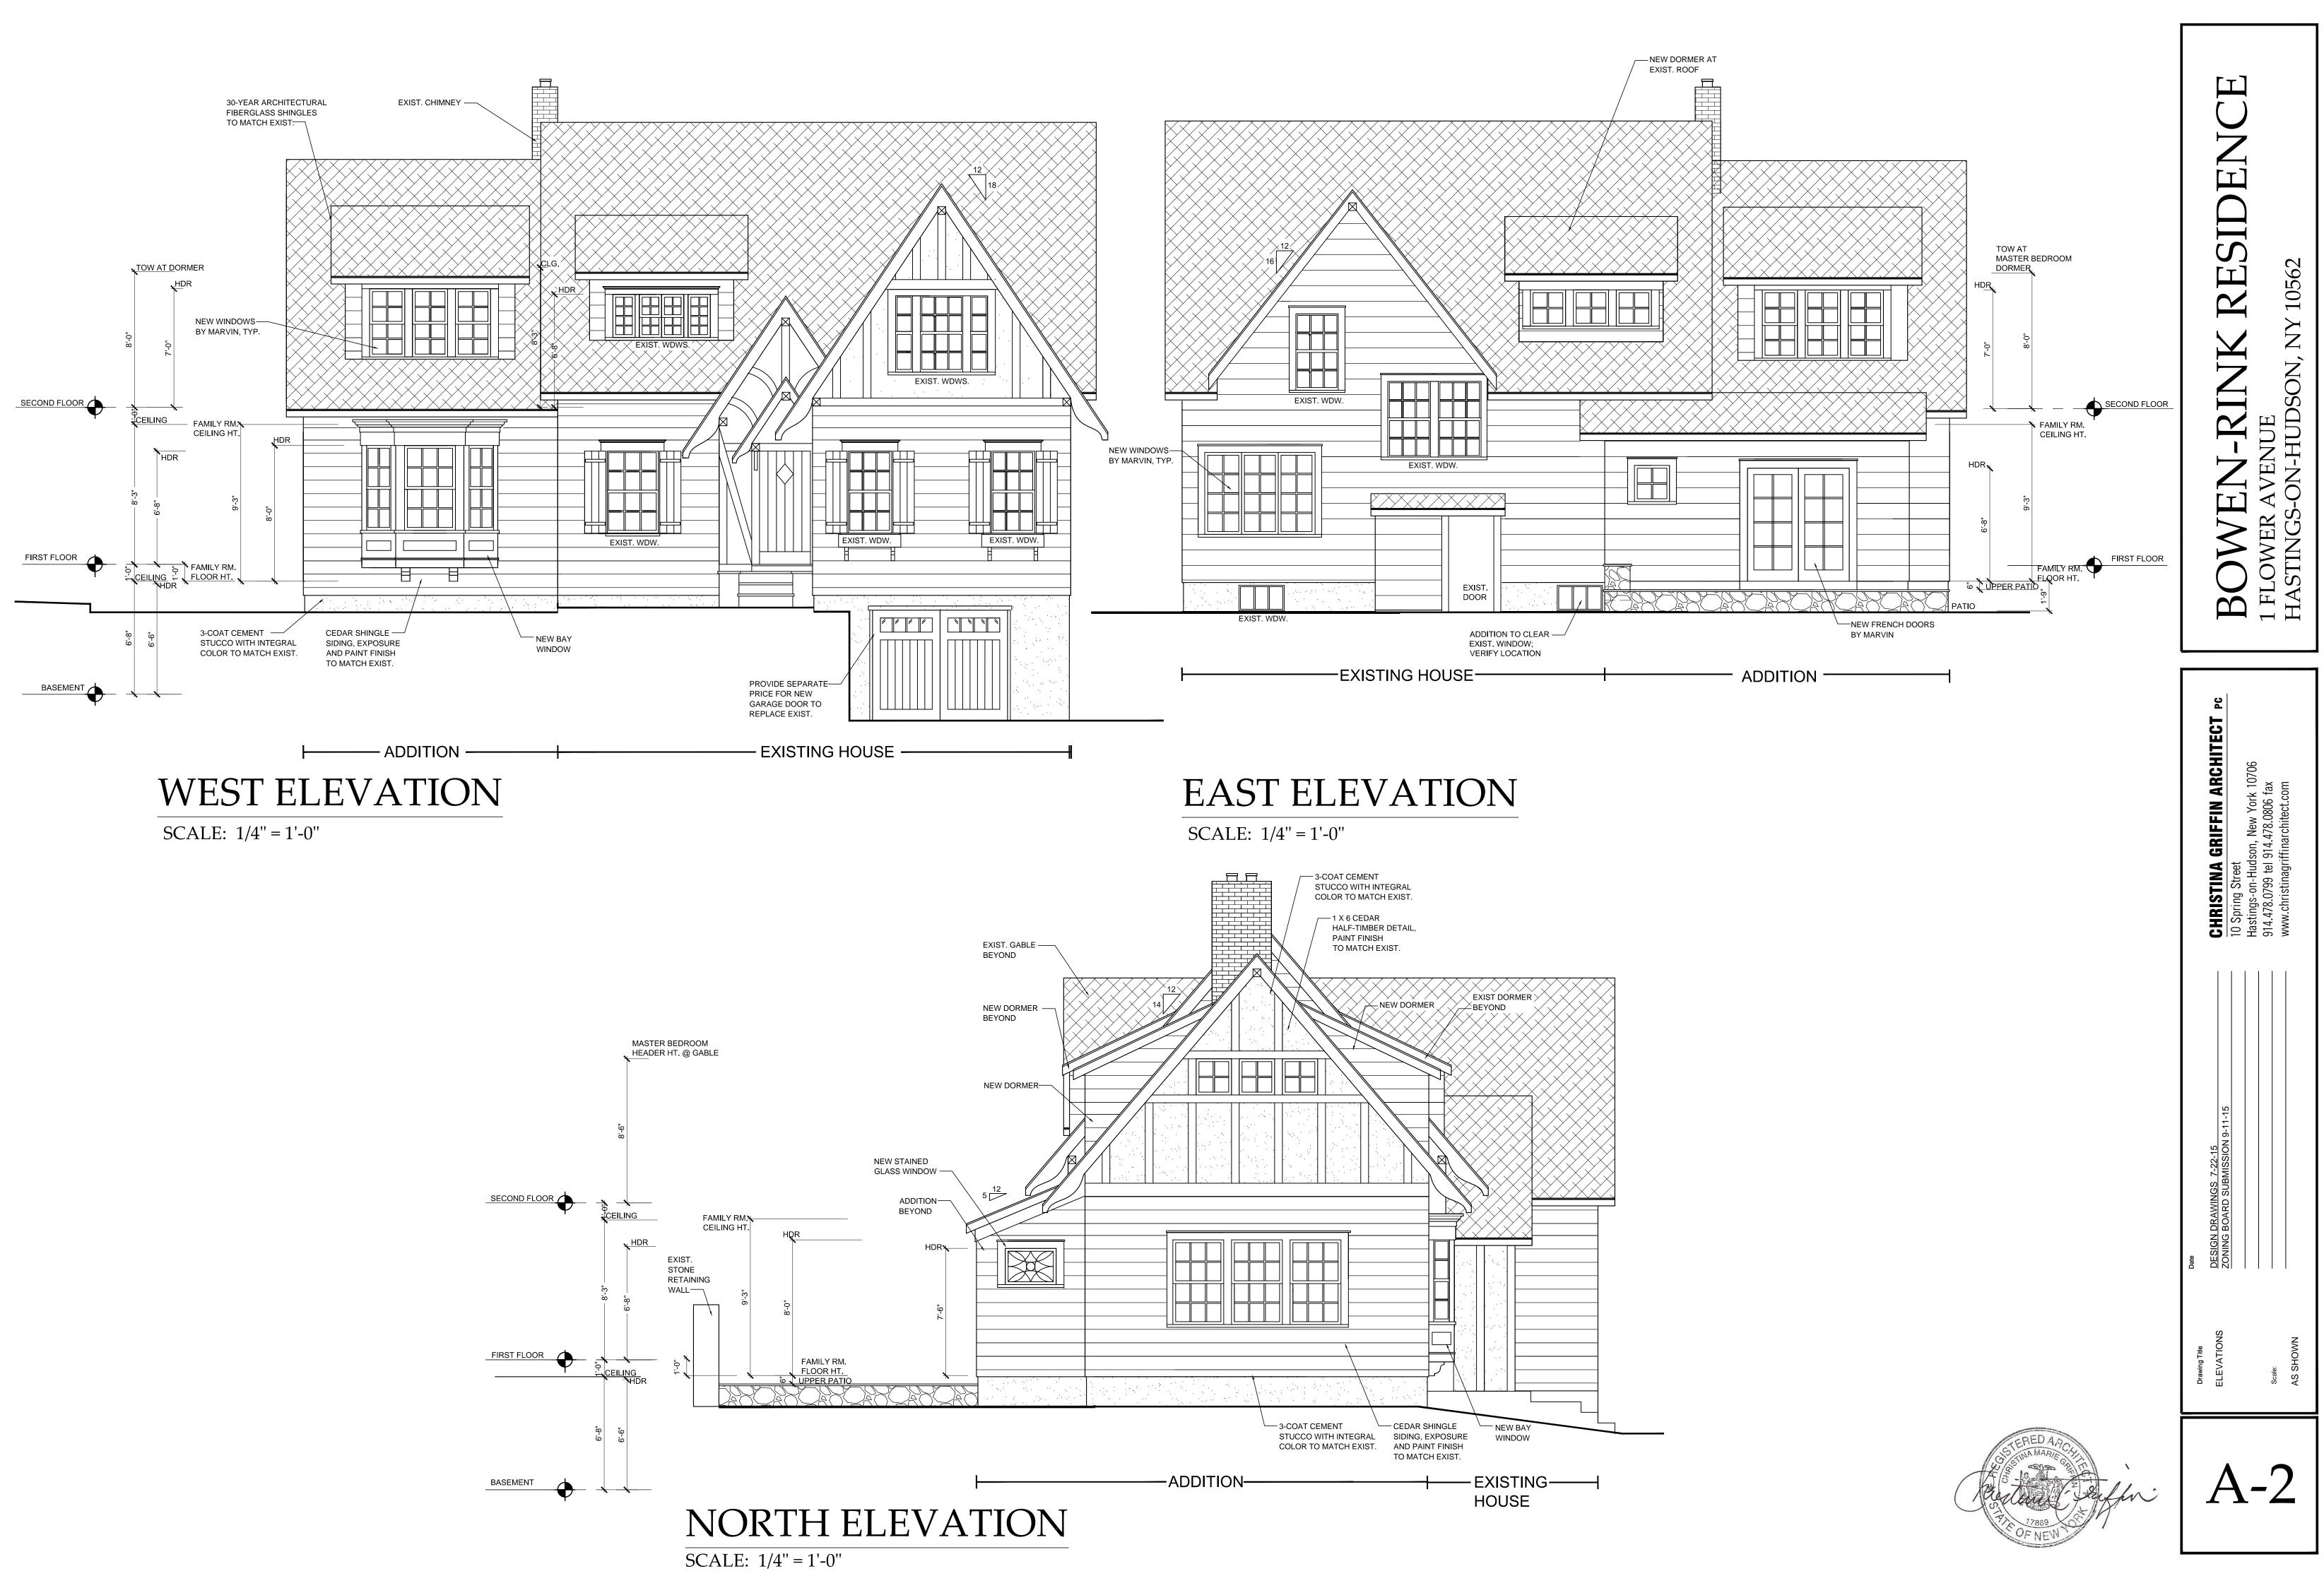

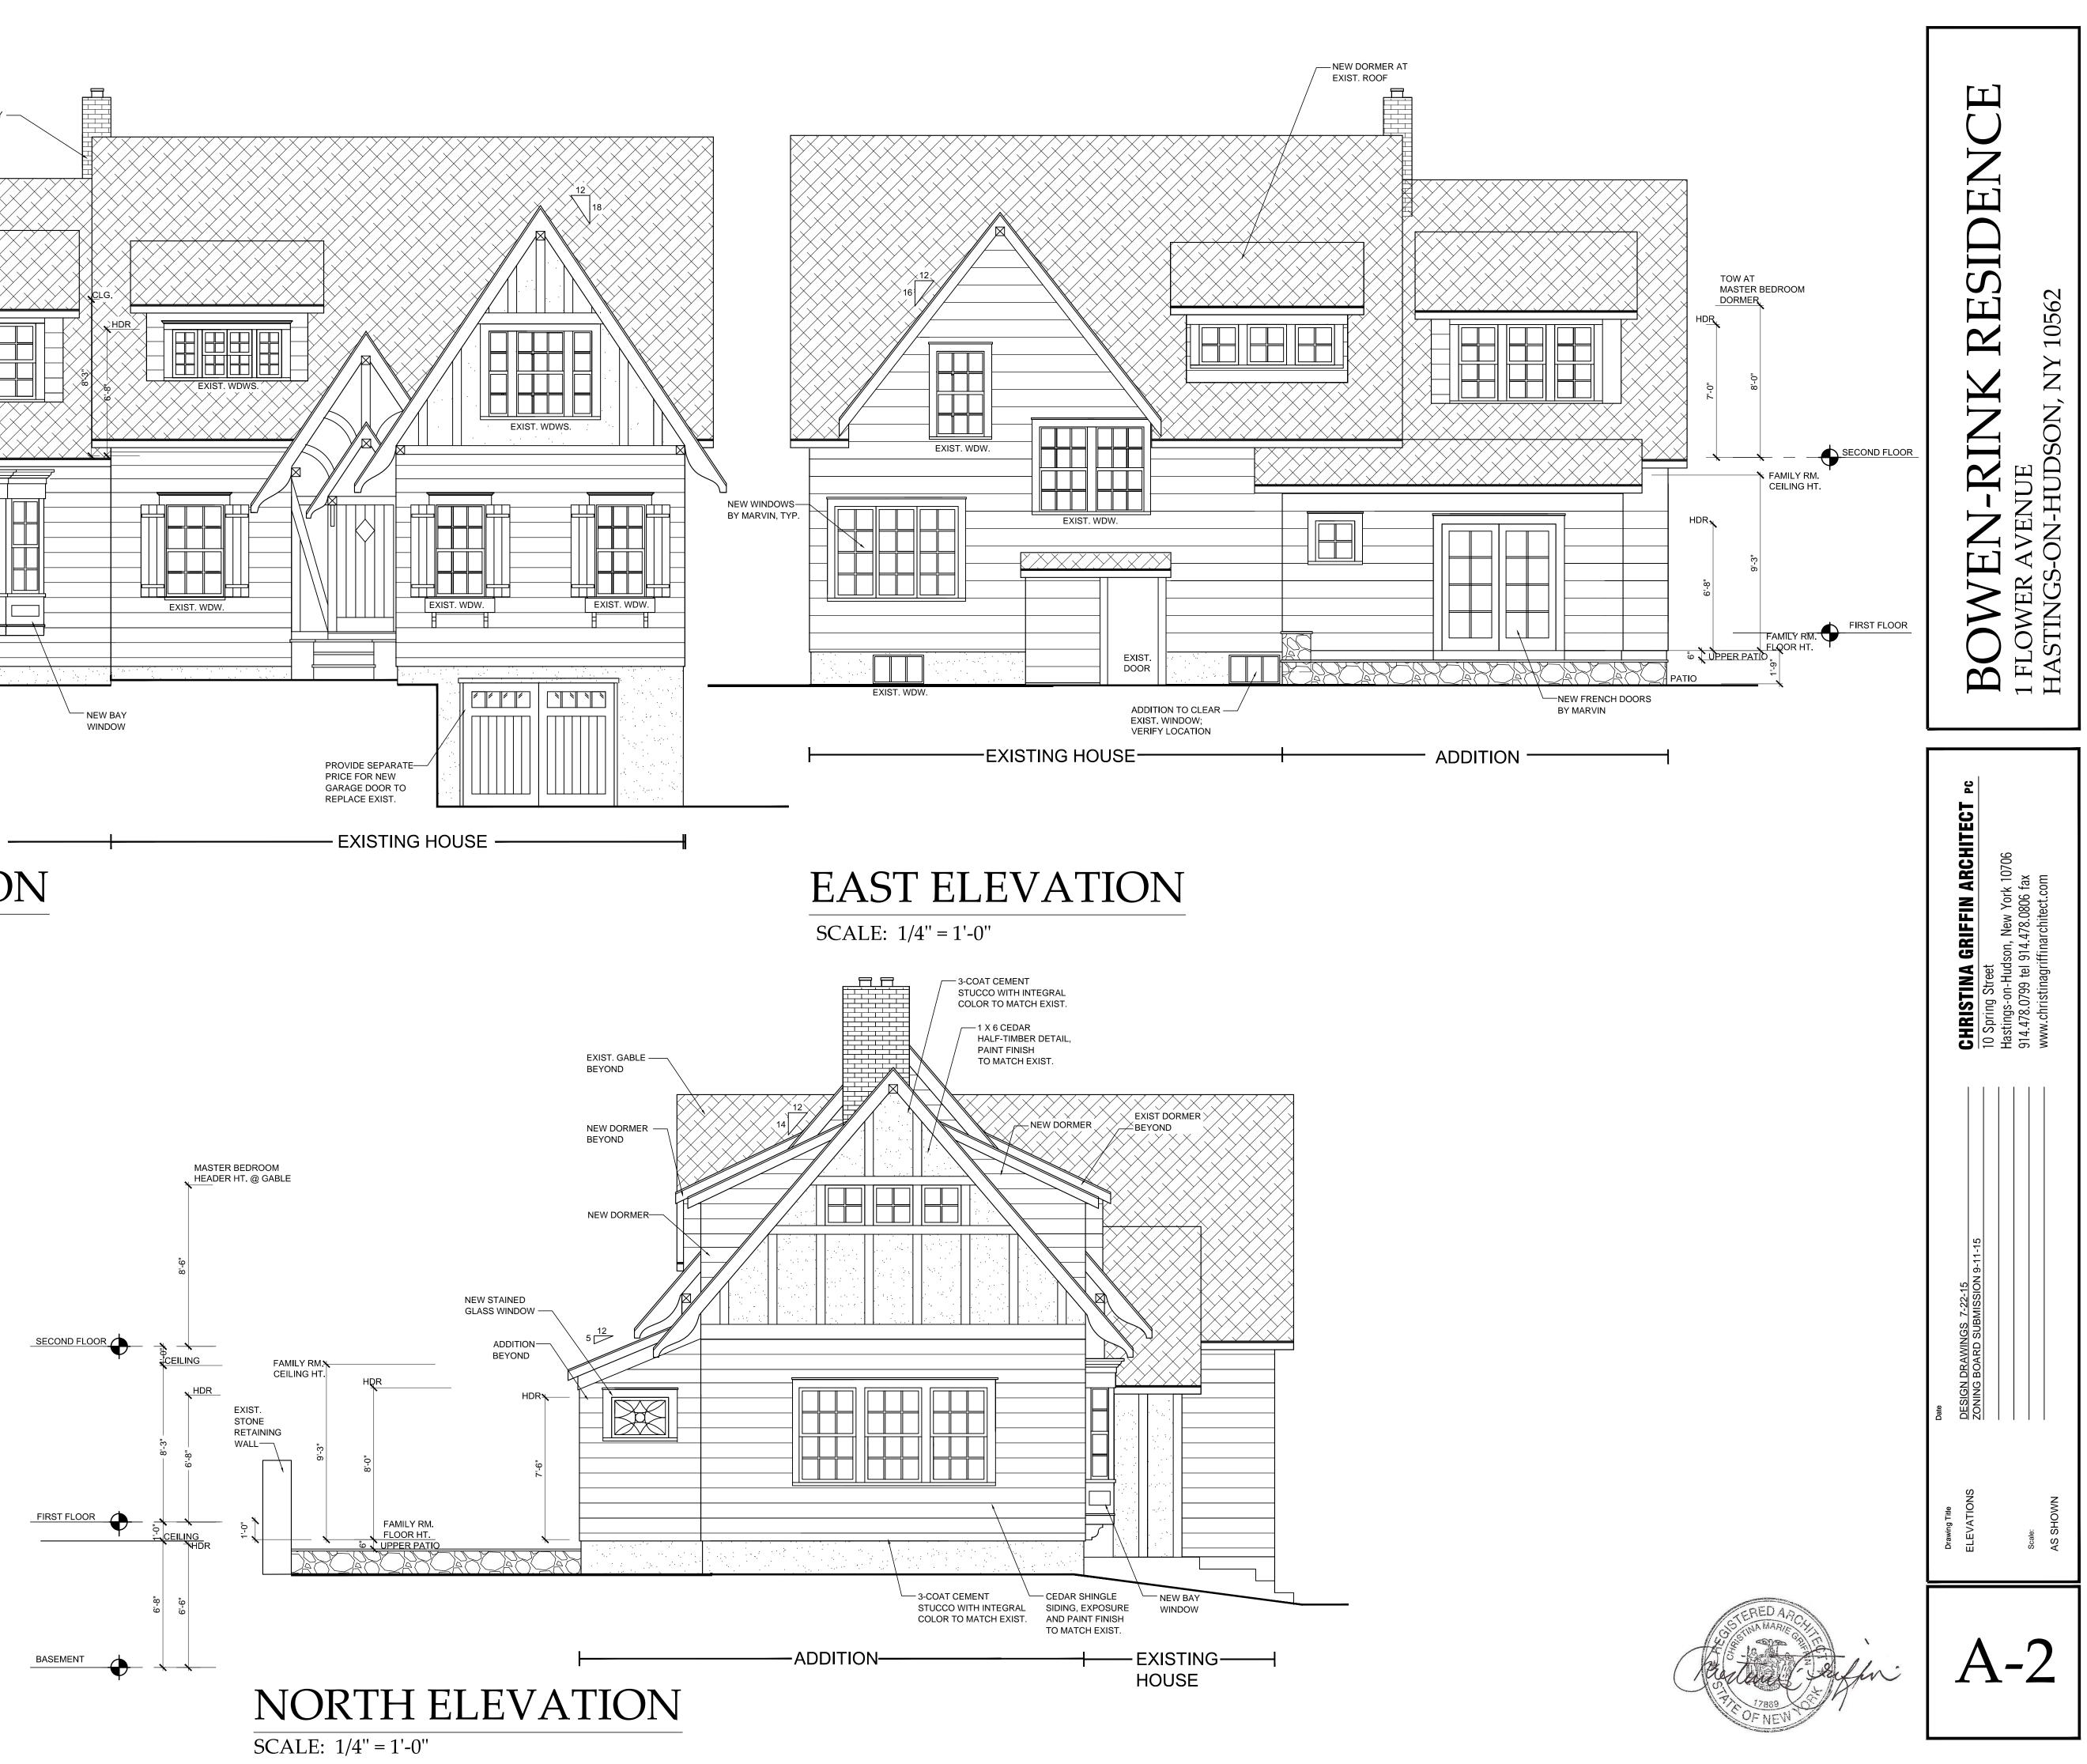

-182.09' 112.997 -

				-Tr			
TABLE OF ZONING DATA	1 FLOWER AVENUE SECTION: 4.20 BLOCK: 9 LOT: 5		ZONING DISTRICT: R-10	COVERAGE CALCULATIONS			LOCATION
	REQUIRED	EXISTING	PROPOSED		8.949 SF /	0.2054 AC	
MIN. LOT SIZE	10,000 SF	8,949 SF	8,949 SF				
					EXIST.	NEW	
WIDTH AT FRONT OF BLDG.	100 FT	249 FT	249 FT	BUILDING	895 SF / 10%	1,308 SF / 14.6%	
	0- 0'			PATIO	319 SF	604 SF	
BUILDING COVERAGE	25 %	10 % (895 SF)	14.6% (1,308 SF)	_			
DEVELOPMENT COVERAGE	35 %	27 % (2,418 SF)	34% (3,043 SF)	STEPS & WALKS	490 SF	417 SF	
(ALL STRUCTURES, DRIVEWAYS, IMPERVIOUS SURFACES)							Temple Beth S
				WALLS	109 SF	109 SF	Temple Beth S
MIN. FRONT YARD	30 FT	25.7 FT	21.1 FT REQUIRES VARIANCE				``~
MIN. REAR YARD	30 FT	14.0 FT	6.9 FT <u>REQUIRES VARIANCE</u>	DRIVEWAY (TOTAL)	605 SF	605 SF	CITE DI ANI I
MIN. SIDE 1 YARD	12 FT	19.0 FT	19.0 FT			000 01	SITE PLAN I
MIN. SIDE 2 YARD	18 FT	131.9 FT	116.9 FT		EXIST.	NEW	
MIN. 2 SIDE YARDS	30 FT	150.9 FT	135.9 FT	TOTAL DEVELOPMENT COVERAGE			
				(ALL BLDG., STRUCTURES, DRIVE-	2,418 SF / 27%	3,043 SF / 34%	PROPOSED NON-CO
MAXIMUM HEIGHT	35 FT / 2.5 STORIES	35 FT / 2 STORIES	35 FT / 2 STORIES				
							<u> </u>

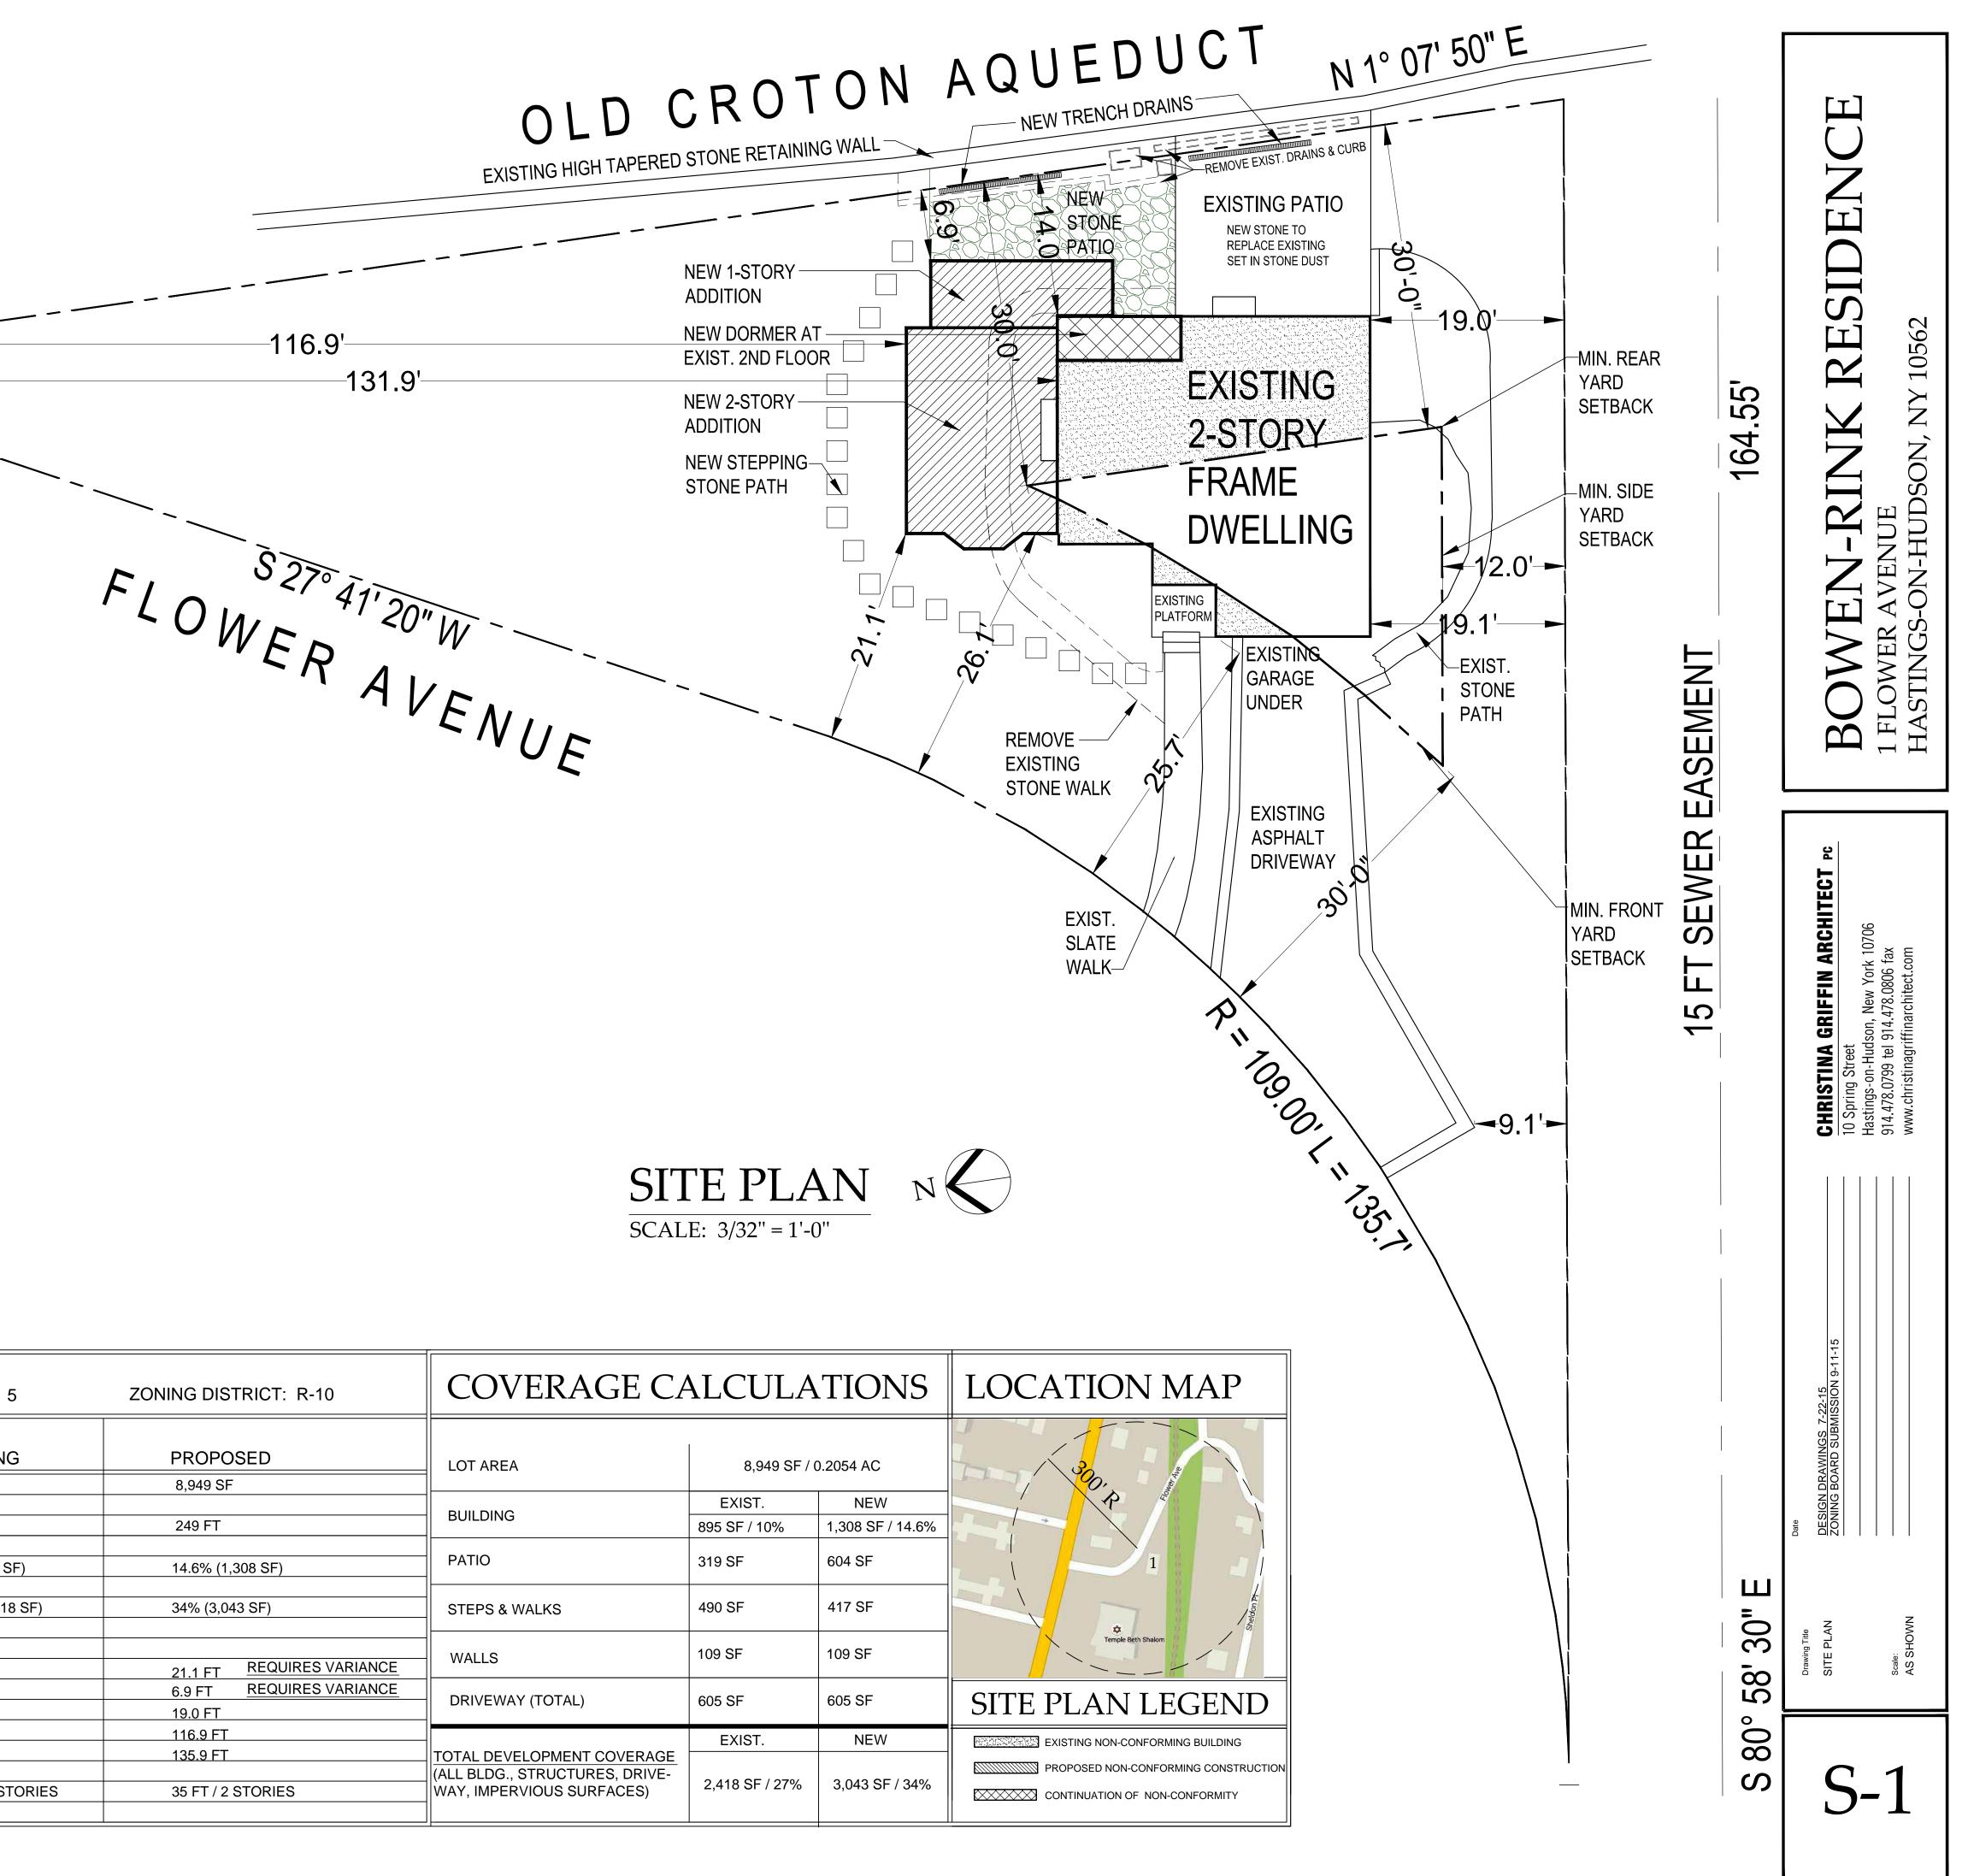







VIEWS OF EXISTING HOUSE at 95 KENT AVENUE

SCALE: N.T.S.




13 FLOWER AVENUE

9 FLOWER AVENUE

11 FLOWER AVENUE

NEIGHBORING PROPERTIES on FLOWER AVENUE


SCALE: N.T.S.

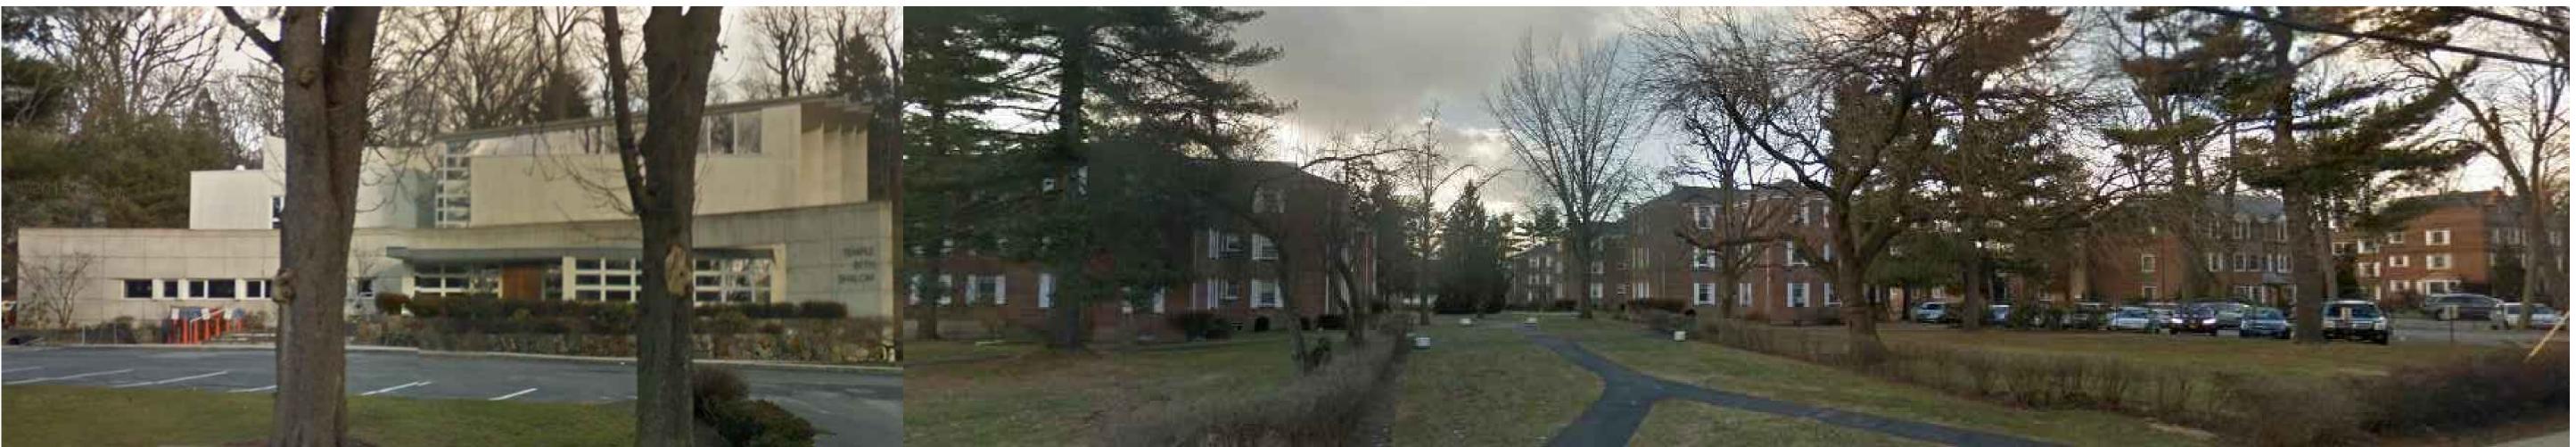


725 BROADWAY NEIGHBORING PROPERTIES on BROADWAY SCALE: N.T.S.





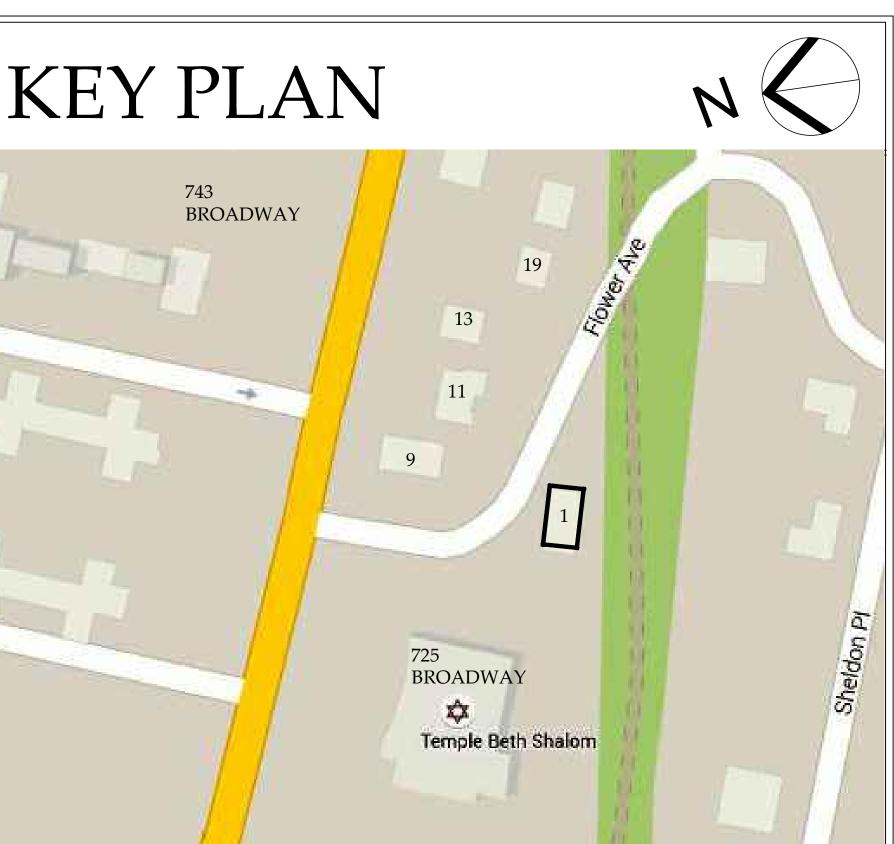

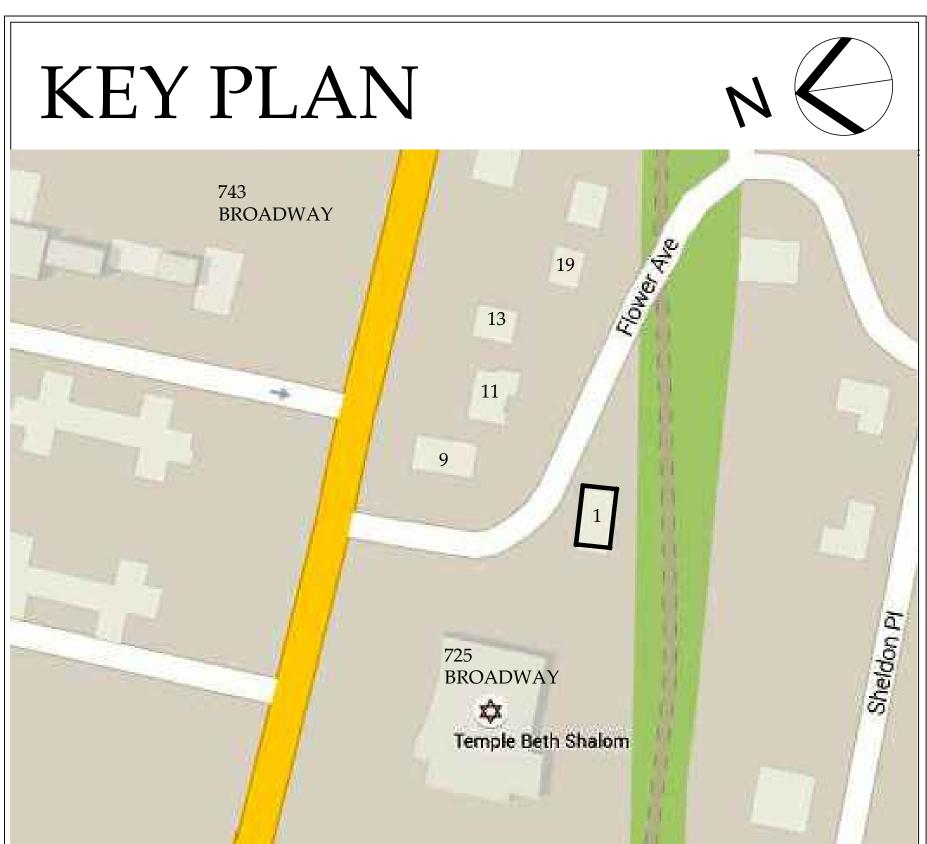

19 FLOWER AVENUE

BOWEN-RINK RESIDENCE 1 FLOWER AVENUE HASTINGS-ON-HUDSON, NY 10562
CHRISTINA GRIFFIN ARCHITECT Pc 10 Spring Street Hastings-on-Hudson, New York 10706 914.478.0799 tel 914.478.0806 fax www.christinagriffinarchitect.com
Drawing Title Date Drawing Title Design Drawing T-22-15 SITE PLAN DESIGN DRAWINGS 7-22-15 SONING BOARD SUBMISSION 9-11-15 Scale: Scale: Scale: Scale:
S-2



GENERAL NOTES

- of the Architect, and may not be used for any purpose whatsoever without written consent of the Architect.
- 2. All construction shall comply fully with the Residential Code of NYS, existing building code of NYS, local building code, fire department regulations, and all other agencies having jurisdiction over project.
- 3. General Contractor shall carry property damage 11. The contractor shall obtain all inspections, insurance, public liability insurance, workman's compensation, auto insurance, and general liability as required by Federal, State, and Local Codes and as Owner requires
- 4. All health, safety, fire, zoning and environmental regulations shall be adhered to at all times by the Owner and/or occupant.
- 5. The contractor shall become familiar with conditions of the site, and the work as shown on the construction documents, prior to submitting a bid for construction.
- 6. Contractors shall coordinate all work procedures and working hours with local authorities, neighborhood associations, and any other governing authorities.
- 7. The contractor shall be responsible for providing all labor and materials to complete the project, in accordance with the construction documents, tested and ready for owner's use.
- 8. All indicated Survey material is for general reference only. The Architect assumes no responsibility for the accuracy or the correctness 14. All dimensions and conditions shown and of any of the indicated material.

- of all existing and new conditions and materials with and adjacent to the construction area. Any damage caused by the execution of the work indicated or implied herein shall be repaired or replaced to the Owner's satisfaction.
- 10. General contractor shall be responsible for the removal of construction debris, rubbish and offsite disposal in a responsible manner.
- approvals and permits, and pay all necessary permit fees required by the local building department and all other agencies having jurisdiction over the project, such as plumbing, electrical & HVAC, except for the building permit, which shall be obtained by the Architect. The contractor shall obtain the certificate of occupancy for the project when construction is complete.
- 2. Contractor shall keep work site free from debris and accumulated refuse, and shall have sole responsibility for protecting all dangerous areas from entry by unauthorized parties.
- 13. Drawings may be rough scaled for estimating and general purposes, but are not to be scaled for construction locations, dimensions, or any other purposes. Dimensions shown shall govern over measurements scaled from plans. Wall dimensions are given to finished surfaces. Contractor to consult with the Architect for questions regarding final dimensions and locations.
- assumed on the drawings must be verified at the site by contractor before ordering any material or doing any work.

- . These documents remain the exclusive property 9. Contractors shall be responsible for protection 15. Contractor is to design and install adequate and 21. The use of the words "provide" or "provided" in code approved shoring and bracing where needed to safely complete structural work. Contractor to assume full and sole responsibility for structural adequacy of the shoring and for any injuries, damages, cracks, or defects caused by shoring or bracing, and shall repair all such damage at his sole expense.
 - 16. The Architect is not responsible for workmanship, construction methods, or any omissions or derivations from the drawings during construction.
 - 17. Materials and products indicated on drawings shall be installed in accordance with manufacturer's requirements.
 - 18. The drawings and notes are intended to be complete. Should anything be omitted from the drawings necessary to the proper construction of the work herein described, it shall be the duty of the contractor to notify the Architect. The builder shall visit the site and inform the Architect of any discrepancies of field conditions that may interfere with the total completion of all work included within the contract and verify all conditions prior to the ordering of materials and the start of construction.
 - 19. Minor details not usually shown or specified, but necessary for proper and acceptable construction, installation or operation of any part of the work shall be included in the work the same as specified or indicated.
 - 20. The contractor shall supervise and direct the work using his best skill and attention, he shall be solely responsible for all construction means, methods, sequences and procedures and for coordination of all portions of the work.

BOWEN-RINK RESIDENCE

1 FLOWER AVENUE, HASTINGS-ON-HUDSON, NY 10706

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10 Spring Street, Hastings-on-Hudson, NY 10706

connection with any item specified is intended to mean that such item be furnished and installed and connected where required.

22.Contractor shall maintain a sealed enclosure between work area and other areas of the residence. In addition, the contractor shall be responsible to (a) protect all interior spaces from the area of renovation, and (b) broom sweep all areas at end of each work day.

23. The contractor shall do all the cutting, fitting & parts of the work come together properly, and to fit his work, and/or receive, or be received by the work of others, as shown, or as reasonably implied on the drawings.

24.New and existing work shall come together in a seamless fashion.All new or modified surfaces shall be finished including, but not limited to taping, spackling and priming.

25. All work shall be guaranteed for one year after final payment. The general contractor is to furnish written guarantees on his work and all subcontractors work against defects resulting from the use of inferior materials, equipment, or workmanship as determined solely by the Architect. All such defects are to be replaced or repaired, complete with labor and materials, at no cost to owner.

26.Substitutions of equipment or materials other than those shown on the drawings or in the specifications shall be made only upon approval of the Architect or owner as noted on the drawings or in these specifications. The contractor shall submit his substitution for

approval before releasing any order for fabrication and/or shipments. The Architect reserves the right to disapprove such substitution, provided in his sole opinion, the item offered is not equal or detailed on the drawings, which requires any redesign of the structure, partitions, piping, redesign, and all new drawings and detailing required therefore shall, with the approval of the Architect, be prepared by the contractor at his own

- expense. patching that may be required to make several 27.All work shall be installed so that all parts required are readily accessible for inspection, operation, maintenance and repair. Minor deviations from the drawings may be made to accomplish this, but changes of magnitude shall not be made without prior written approval from the Architect.
 - 28.Upon completion of the work, the entire project is to be completely cleaned and the site restored to existing condition, including but not limited to the following:
 - a) Complete sweeping of all areas, and removal of all rubbish and debris, except that caused by the owner or others doing I, Christina Griffin, Architect A.I.A., hereby states N.I.C. work.
 - b) Removal of all labels from glass, fixtures, and equipment, etc. and spray cleaning of glass and mirrors.
 - c) Removal of stains, and paint from glass, hardware, finished flooring, cabinets, etc.
 - d) Final cleaning of all chrome and aluminum metal work.

e) Restoration of property by returning shrubs to original locations, filling of all ruts and raked topsoil and repairs to damaged blacktop.	
9.Finish materials and paint colors shall be	

reviewed and approved by the homeowner. 30. The Architect assumes no responsibility for the accuracy or correctness of any material or drawings prepared by others and provided to the Architect.

Energy Notes R-Values & U-Factors NIVE Energy Code

NYS Energy Code						
Climate Zon	e 4					
	Required	Proposed				
Ceiling	R-38	R-38				
Wall	R-13	R-18				
Glazing	0.35	0.32				
Floor	R-19	R-30				

Design Criteria: 5750 Degree Days

15% Maximum Glazing

Certification

that I have prepared these plans and specifications to the best of my knowledge in compliance with all the requirements of the 2010 Residential Code of New York State, and the 2010 New York State Energy Conservation Construction code.

INSULATION AND FENESTRATION REQUIREMENT BY COMPONENT						DATES				
CLIMATE ZONE							ZONING BOARD SUBMISSION 9-11-15			
4		0.35		0.60	;	38	13			
MASS WAL R-VALUE		FLOOR R-VALUE		EMENT (C) R-VALUE			WL SPACE (C) L R-VALUE			
5/10 (g	g)	19	10)/13 (C)	10, 2	2FT (d)	10/13 (C)			
 COMPRESSED INTO 2X6 CAVITY. b. THE FENESTRATION U-FACTORS COLUMN EXCLUDES SKYLIGHTS. c. THE FIRST R-VALUE APPLIES TO CONTINUOUS INSULATION, THE SECOND TO FRAMING CAVITY INSULATION; EITHER INSULATION MEETS THE REQUIREMENTS. d. R-5 SHALL BE ADD TO THE REQUIRED SLAB EDGE R-VALUES FOR HEATED SLABS. g. THE SECOND R-VALUES APPLIES WHEN MORE THAN HALF THE INSULATION IS ON THE EXTERIOR OF THE MASS WALL. 						LIS	T of DRAWINGS			
DESIGN REQUIREMENTS for the 2010 RESIDENTIAL CODE OF NEW YORK STATE CLIMATIC & GEOGRAPHIC DESIGN CRITERIA						TITLE SHEET S-1	GENERAL NOTES, ZONING DATA, CLIMATIC & GEOGRAPHIC CRITERIA, DATES, LIST OF DRAWINGS, SITE PLAN, ZONING COMPLIANCE			
SUBJECT TO DAMAGE FROM				S-2	LOCATION MAP, VIEW OF PROPERTY, VIEW OF NEIGHBORING PROPERTIES					
SNOW	SPEED	SEISMIC DESIGN CATEGORY	WEATHERING	FROST LINE DEPTH		ICE SHIELD UNDERLAYMENT REQUIRED	FLOOD HAZARDS	A-1 A-2	FIRST & SECOND FLOOR PLANS EXTERIOR ELEVATIONS	
20 psf 1	100-110	С	severe	42" min	medium to heavy	yes	NO			

